# ANNE ARUNDEL COUNTY, MARYLAND, DEPARTMENT OF PUBLIC WORKS WATERSHED PROTECTION AND RESTORATION PROGRAM CAPE ST CLAIRE SHORELINE ENHANCEMENT

# VICINITY MAP



## **GENERAL NOTES**

- 1. ALL TOPOGRAPHIC SURVEY DATA SHOWN WAS OBTAINED FROM SUSTAINABLE SCIENCES, LLC, COORDINATES AND ELEVATIONS ARE REFERRED TO THE MARYLAND STATE PLANE COORDINATE SYSTEM AND NORTH ATLANTIC VERTICAL DATUM OF 1988 (NAD 83/2011 & NAVD88).
- 2. ALL CONSTRUCTION SHALL BE IN ACCORDANCE WITH THE ANNE ARUNDEL COUNTY DEPARTMENT OF PUBLIC WORKS "STANDARD DETAILS AND SPECIFICATIONS" UNLESS OTHERWISE NOTED.
- 3. THE EXISTING UTILITIES AND OBSTRUCTIONS SHOWN ARE FROM THE BEST AVAILABLE RECORDS AND SHALL BE VERIFIED BY THE CONTRACTOR TO HIS SATISFACTION PRIOR TO CONSTRUCTION. NECESSARY PRECAUTIONS SHALL BE TAKEN BY THE CONTRACTOR TO PROTECT EXISTING SERVICES AND MAINS AND ANY DAMAGE TO THEM SHALL BE REPAIRED IMMEDIATELY AT HIS OWN EXPENSE.
- 4. IT SHALL BE UNDERSTOOD THAT FAILURE TO MENTION SPECIFICALLY ANY WORK WHICH WOULD NATURALLY BE REQUIRED TO COMPLETE THE PROJECT SHALL NOT RELIEVE THE CONTRACTOR OF HIS RESPONSIBILITY TO COMPLETE SUCH WORK.

## SITE ANALYSIS TABULATION

1.	TOTAL AREA OF PROPERTY	2.4 AC (L
2.	DISTURBED AREA	0.4 AC A
3.	IN STREAM AREA NOT TO BE STABILIZED	N / A
4.	AREA MECHANICALLY STABILIZED	N / A
5.	AREA VEGETATIVELY STABILIZED	445 SF
6.	TOTAL CUT	N / A
7.	TOTAL FILL	N / A
8.	TOTAL SPOIL	N / A
9.	TOTAL IMPORTED FILL	1000 CY
* –		

\* ESTIMATED INFORMATION NOT INTENDED FOR BIDDING

# Reuse of Documents:



CALL "MISS UTILITY" (1-800-257-7777) A MINIMUM OF 48 HOURS IN ADVANCE OF ANY EXCAVATION, BORING, PILE DRIVING AND/OR DIGGING FOR THE LOCATION OF GAS, ELECTRIC, TELEPHONE, WATER, SEWER, CABLE TV LINES, ETC.

MISS UTILITY

# CONSTRUCTION DOCUMENTS GRADING PERMIT NO.

Sheet List Table					
Sheet Description	Sheet Number	Sheet Title			
	1	TITLE SHEET			
AB-01	2	GENERAL NOTES & LEGEND			
SL-01	3	SHEET LAYOUT & KEY MAP			
EF-01	4	EXISTING CONDITIONS - MAIN BEACH			
EF-02	5	EXISTING CONDITIONS - LAKE CLAIRE			
C-01	6	PROPOSED CONDITIONS - MAIN BEACH			
C-02	7	PROPOSED CONDITIONS - LAKE CLAIRE			
CS-01	8	CROSS SECTIONS			
DE-01	9	DETAILS - LAKE CLAIRE			
SC-01	10	SEQUENCE OF CONSTRUCTION			
ES-01	11	EROSION AND SEDIMENT CONTROL - MAIN BEACH			
ES-02	12	EROSION AND SEDIMENT CONTROL - LAKE CLAIRE			
ES-03	13	EROSION AND SEDIMENT CONTROL NOTES			
ES-04	14	EROSION AND SEDIMENT CONTROL NOTES			
ES-05	15	EROSION AND SEDIMENT CONTROL DETAILS			
LS-01	16	PLANTING PLAN - MAIN BEACH			
LS-02	17	PLANTING PLAN - LAKE CLAIRE			
LS-03	18	PLANTING DETAILS			

## CONSULTANT'S CERTIFICATION

"THE DEVELOPER'S PLAN TO CONTROL SILT AND EROSION IS ADEQUATE TO CONTAIN THE SILT AND EROSION ON THE PROPERTY COVERED BY THE PLAN." I CERTIFY THAT THIS PLAN OF EROSION AND SEDIMENT CONTROL REPRESENTS A PRACTICAL AND WORKABLE PLAN BASED ON MY PERSONAL KNOWLEDGE OF THIS SITE. AND WAS PREPARED IN ACCORDANCE WITH THE REQUIREMENTS OF THE ANNE ARUNDEL SOIL CONSERVATION DISTRICT PLAN SUBMITTAL GUIDELINES AND THE CURRENT MARYLAND STANDARDS AND SPECIFICATIONS FOR SEDIMENT AND EROSION CONTROL. I HAVE REVIEWED THIS SEDIMENT AND EROSION CONTROL PLAN WITH YHE OWNER/DEVELOPER.

MD. P.E. LICENSE # 18919


MD. LAND SURVEYOR LICENSE# MD. LANDSCAPE ARCHITECT #

NAME F. ALBERT MCCULLOUGH III

FIRM NAME

SUSTAINABLE SCIENCE, LLC 410 SOUTH SECOND ST. STREET ADRESS

DENTON, MD 21629

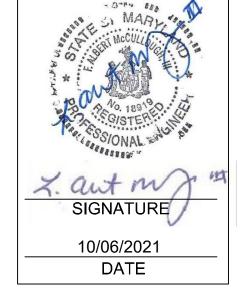

SEAL

I (WE) CERTIFY THAT:

DISTURBANCE OR RE-DISTURBANCE, PERMANENT AND/OR TEMPORARY STABILIZATION PER THE AASCD DETAILS AND SPECIFICATIONS FOR VEGETATIVE ESTABLISHMENT SHALL BE COMPLETED WITHIN THREE CALENDAR DAYS FOR THE SURFACE OF ALL CONTROLS DIKES SWALES DITCHES PERIMETER SLOPES AND ALL SLOPES GREATER THAN 3 HORIZONTAL TO 1 VERTICAL (3:1): AND SEVEN DAYS FOR ALL OTHER DISTURBED OR GRADED AREAS ON THE PROJECT SITE

STATE OR COUNTY REQUIREMENTS PERTAINING TO ENVIRONMENTAL ISSUES 6. THE DEVELOPER MUST REQUEST THAT THE SEDIMENT AND EROSION CONTROL INSPECTOR APPROVE WORK COMPLETED IN ACCORDANCE WITH THE APPROVED EROSION AND SEDIMENT CONTROL PLAN. THE GRADING OR BUILDING PERMIT AND THE ORDINANCE

REQUIRE FIRST PHASE INSPECTION. OTHER BUILDING OR GRADING INSPECTION APPROVALS MAY NOT BE AUTHORIZED UNTIL THE INITIAL APPROVAL BY THE SEDIMENT AND EROSION CONTROL INSPECTOR IS GIVEN.

SIGNATURE PRINT:

(LIMITS OF DISTURBANCE)

ABOVE MHW

B. ENGINEER INFORMATION - SUSTAINABLE SCIENCE, LLC. AND BIOHABITATS, INC. C. TAX MAP/PARCEL- SEE PLANS

A. OWNER INFORMATION - CAPE ST. CLAIRE IMPROVEMENT ASSOCIATION

- D. PLAT REFERENCE SEE PLANS
- E. PROPERTY AREA SEE PLANS DISTRICT - 03

SITE INFORMATION TABULATION

- G. ZONING R5, OS
- H. STREAM USE DESIGNATION CLASS II
- I. SUBWATERSHED/WATERSHED MD 8 DIGIT 02131001/MAGOTHY RIVER **CRITICAL AREA - YES**

QA/QC STATEME THESE PLANS H AND APPROVED SCHEMATIC DES Z. aut m

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A DULY LICENSED PROFESSIONAL ENGINEER UNDER THE LAWS OF THE STATE OF MARYLAND LICENSE #: 18919

PROFESSIONAL CERTIFICATION

HEREBY CERTIFY THAT THESE

DOCUMENTS WERE PREPARED OR

APPROVED BY ME, AND THAT I AM

EXPIRATION DATE:	11/16/2022

CHIEF

STANDARD RESPONSIBILITY NOTES

a. ALL DEVELOPMENT AND CONSTRUCTION WILL BE DONE IN ACCORDANCE WITH THIS SEDIMENT AND EROSION CONTROL PLAN, AND FURTHER. AUTHORIZE THE RIGHT OF ENTRY FOR PERIODIC ON-SITE EVALUATION BY THE ANNE ARUNDEL SOIL CONSERVATION AASCD BOARD OF SUPERVISORS OR THEIR AUTHORIZED AGENTS

D. ANY RESPONSIBLE PERSONNEL INVOLVED IN THE CONSTRUCTION PROJECT WILL HAVE A CERTIFICATE OF ATTENDANCE MARYLAND DEPARTMENT OF THE ENVIRONMENT'S APPROVED TRAINING PROGRAM FOR THE CONTROL OF SEDIMENT AND EROSION **BEFORE BEGINNING THE PROJECT** 

RESPONSIBLE PERSONNEL ON SITE: JIM FAVRET, BIOHABITATS, INC

c. IF APPLICABLE, THE APPROPRIATE ENCLOSURE WILL BE CONSTRUCTED AND MAINTAINED ON SEDIMENT BASIN(S) INCLUDED IN THIS PLAN. SUCH STRUCTURE(S) WILL BE IN COMPLIANCE WITH THE ANNE ARUNDEL COUNTY CODE

2. THE DEVELOPER IS RESPONSIBLE FOR THE ACQUISITION OF ALL EASEMENTS, RIGHT, AND/OR RIGHTS-OF-WAY THAT MAY BI REQUIRED FOR THE SEDIMENT AND EROSION CONTROL PRACTICES. STORM WATER MANAGEMENT PRACTICES AND THE DISCHARG

DISTURBANC 5 THE APPROVAL OF THIS PLAN FOR SEDIMENT AND FROSION CONTROL DOES NOT

9. APPROVAL SHALL BE REQUESTED ON FINAL STABILIZATION OF ALL SITES BEFORE REMOVAL OF SEDIMENT AND EROSION CONTROLS 10. EXISTING TOPOGRAPHY MUST BE FIELD VERIFIED BY RESPONSIBLE PERSONNEL TO THE SATISFACTION OF THE SEDIMENT CONTROL INSPECTOR PRIOR TO COMMENCING WORK. 01000 10.1

S.R.P.T	10/8/2021
E OF DEVELOPER/OWNER	DATE
NAME: <u>BEAU BREEDEN</u> TITLE: <u>B&amp;P CHAIR, CAPE ST. CLAIRE IMPROVEN</u> AFFILIATION: <u>CAPE ST. CLAIRE IMPROVEMENT</u> ADDRESS: <u>1223 RIVER BAY RD., ANNAPOLIS,</u> TELEPHONE NUMBER: <u>(410) 757-1223</u> EMAIL ADDRESS: <u>OFFICE@CSCIA.ORG</u>	ASSOCIATION

ANNE ARUNDEL SOIL CONSERVATION DISTRICT
SEDIMENT AND EROSION CONTROL APPROVAL

		A CONTRACTOR OF THE STATE	MARI MCCULL Vo. 18919 VSTERL ONAL			
EMENT:		PROFESSIONAL CE	PROFESSIONAL CERTIFICATION			
IS HAVE BEEN REV VED BY ME FOR DESIGN SUBMITTA	AL	I HEREBY CERTIFY WERE PREPARED O THAT I AM A DULY L ENGINEER UNDER OF MARYLAND. LICENSE #: 18919 EXPIRATION DATE:	DR APPROVE ICENSED PI THE LAWS C 11/16/202	ED BY ME, ANI ROFFESIONAL OF THE STATE 2		
for any other project	without the	e written authorizatior		-	-	
				CLAIRE		
		1MUNITY IMF	PROVE	EMENT	ASSOCI	ATION
APPROVED	DATE	APPROVED	DATE	SCALE:	AS SHOWN	CAPE ST CLAIRE SHORELINE
CHIEF ENGINEER		PROJECT MANAGER		DRAWN BY	TB,RW,AM,SE	ENHANCEMENT
APPROVED	DATE		DATE	CHECKED BY	FAM, JC	
	DATE	APPROVED	DATE	SHEET NO.	1 OF 18	TITLE SHEET
				PROJECT NO.	19033.01	
ASSISTANT CHIEF ENGINEER		CHIEF, RIGHT-OF-WAY		PROPOSAL NO.		

	ERAL NOTES	ABBREVIA	TIONS
1.			
	SURVEY WAS COMPLETED. IT IS THE CONTRACTOR'S RESPONSIBILITY TO CONFIRM EXISTING GRADES AND ADJUST QUANTITIES, EARTHWORK AND	RCP	REINF
	WORK EFFORTS AS NECESSARY AT NO ADDITIONAL COST TO THE PROJECT	CMP	CORF
	OWNER. THIS IS NOT TO BE CONSTRUED AS A BOUNDARY SURVEY.	INV	PIPE
2.		CLF	CHAI
	COUNTY DEPARTMENT OF PUBLIC WORKS "STANDARD DETAILS AND	FT	FEET
	SPECIFICATIONS" UNLESS OTHERWISE NOTED.		
3.	THE EXISTING UTILITIES SHOWN WITHIN THE SURVEY LIMITS HAVE BEEN	CONC	CONC
	FIELD LOCATED. THE CONTRACTOR SHALL VERIFY ALL LOCATIONS TO HIS	HDWL	HEAD
	SATISFACTION PRIOR TO CONSTRUCTION. NECESSARY PRECAUTIONS SHALL BE TAKEN BY THE CONTRACTOR TO PROTECT EXISTING SERVICES	ELEV	ELEV
	AND MAINS AND ANY DAMAGE TO THEM SHALL BE REPAIRED IMMEDIATELY		
	AT HIS OWN EXPENSE.	INV	INVEF
4.	IT SHALL BE UNDERSTOOD THAT FAILURE TO MENTION SPECIFICALLY ANY	PCCMP	POLY
	WORK WHICH WOULD NATURALLY BE REQUIRED TO COMPLETE THE		
	PROJECT SHALL NOT RELIEVE THE CONTRACTOR OF HIS RESPONSIBILITY	FEMA	FEDE
F	TO COMPLETE SUCH WORK.	WUS	WATE
5.	THE CONTRACTOR SHALL CALL "MISS UTILITY" (1-800-257-7777) A MINIMUM OF 48 HOURS IN ADVANCE OF ANY EXCAVATION, BORING, PILE DRIVING	ES	END S
	AND/OR DIGGING FOR THE LOCATION OF GAS, ELECTRIC, TELEPHONE,		
	WATER, SEWER, CABLE TV LINES, ETC.	WL	WETL
6.	CONTRACTOR SHALL EXERCISE CARE WHEN DIGGING ADJACENT TO AND	SAN	SANIT
	CROSSING THE UTILITIES. ANY DAMAGE TO THE UTILITIES IS THE	00	
_	CONTRACTORS RESPONSIBILITY.	SS	SANI
7.	THE CONTRACTOR SHALL NOTIFY THE ANNE ARUNDEL COUNTY	STA	STAT
	INSPECTIONS PERMITS CENTER (410-222-7780) TWO (2) DAYS PRIOR TO BEGINNING CONSTRUCTION.	WSE	WATE
8.	THE CONTRACTOR MUST STORE ALL EQUIPMENT WITHIN THE LOD AND ALL		
0.	CONSTRUCTION ACTIVITIES AND ACCESS MUST REMAIN WITHIN THE LOD AS	TYP	TYPIC
	SHOWN ON THE PLANS.	MIN	MINIM
9.	CONTRACTOR SHALL PERFORM FULL WIDTH REPAIR OR REPLACE ANY		
	DAMAGED ROADS, CURBS, FENCES, DRIVEWAY, AND SIDEWALKS IN KIND.	APPROX	APPR
10.	CONTRACTOR SHALL VERIFY SITE CONDITIONS AND REPORT ANY	W/	WITH
	DISCREPANCIES TO THE ENGINEER/DESIGNATED SPECIALIST PRIOR TO BEGINNING CONSTRUCTION.	AC	ACRE
11.	CONTRACTOR SHALL PROTECT ALL ROADS, DRIVEWAYS AND SIDEWALKS FOR	AC	AUNL
	DAMAGE. ANY DAMAGE TO THEM SHALL BE REPAIRED AT HIS OWN EXPENSE.	CY	CUBIC
12.	THE GRADING TOLERANCE IS +/- 0.2' VERTICAL AND +/- 0.5' HORIZONTAL.	DBH	DIAM
	STRUCTURE ELEVATION/LOCATIONS AND GRADING MAY BE FIELD ADJUSTED		
	AT THE DIRECTION OF THE PROJECT ENGINEER/DESIGNATED SPECIALIST.	CRZ	CRITI
		LOD	LIMIT
		BOF	BLAZI

Reuse of Documents:



# LEGEND

- INFORCED CONCRETE PIPE
- DRRUGATED METAL PIPE
- PE INVERT
- IAIN LINK FENCE
- ET
- ONCRETE
- ADWALL
- EVATION
- VERT
- DLYMER COATED CORRUGATED METAL PIPE
- DERAL EMERGENCY MANAGEMENT AGENCY
- ATERS OF THE US
- D SECTION
- ETLAND
- NITARY
- ANITARY SEWER
- ATION
- ATER SURFACE ELEVATION
- PICAL
- NIMUM
- PROXIMATE
- TΗ
- RES
- JBIC YARD
- AMETER AT BREAST HEIGHT
- RITICAL ROOT ZONE
- WIT OF DISTURBANCE
- AZE ORANGE FENCE

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ING	
LIMIT OF SURVEY	-
MAJOR CONTOUR	-
MINOR CONTOUR	-
GIS CONTOUR	-
MEAN HIGH WATER (1.12')	_
MEAN LOW WATER (0.15')	
CRITICAL AREA BOUNDARY	
SOIL BOUNDARY	
FLOW PATH	
PROPERTY LINE (GIS)	
PROPERTY LINE (PLAT)	
FENCE	_
TREELINE (GPS)	
TRAVERSE POINT	(
BENCH (GPS)	
POWER POLE	
STEEP SLOPES 15% - 20%	

STEEP SLOPES > 25%

BREAKWATER

OVERHEAD UTILITY LINE

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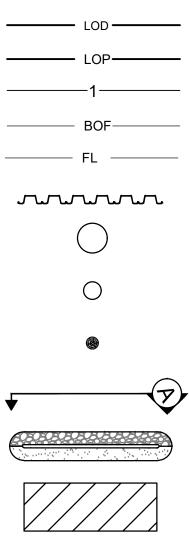
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PROFESSIONAL CERTIFICATION

EXPIRATION DATE: 11/16/2022

APPRC CHIEF APPRO ASSIS

## PROPO




DSED					
LIMIT OF DISTURBANCE					
LIMIT OF PLANTING					
MINOR CONTOUR					
BLAZE ORANGE FENCE					
FILTER LOG					
BATTEN BOARD GROIN					
36" OYSTER STRUCTURE					
24" OYSTER STRUCTURE					
INVERTED ROOT WAD					
CROSS SECTION					
COBBLE BAR					

STAGING/STOCKPILE AREA


STONE GROIN

CAPE ST CLAIRE							
COMMUNITY IMPROVEMENT ASSOCIATION							
ROVED	DATE	APPROVED	DATE	SCALE:	N/A	CAPE ST CLAIRE SHORELINE	
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EF ENGINEER		PROJECT MANAGER		CHECKED BY	FAM, JC		
ROVED	DATE	APPROVED	DATE	SHEET NO.	2 OF 18	GENERAL NOTES & LEGEND	
				PROJECT NO.	19033.01		
ISTANT CHIEF ENGINEER		CHIEF, RIGHT-OF-WAY		PROPOSAL NO.		AB-01	

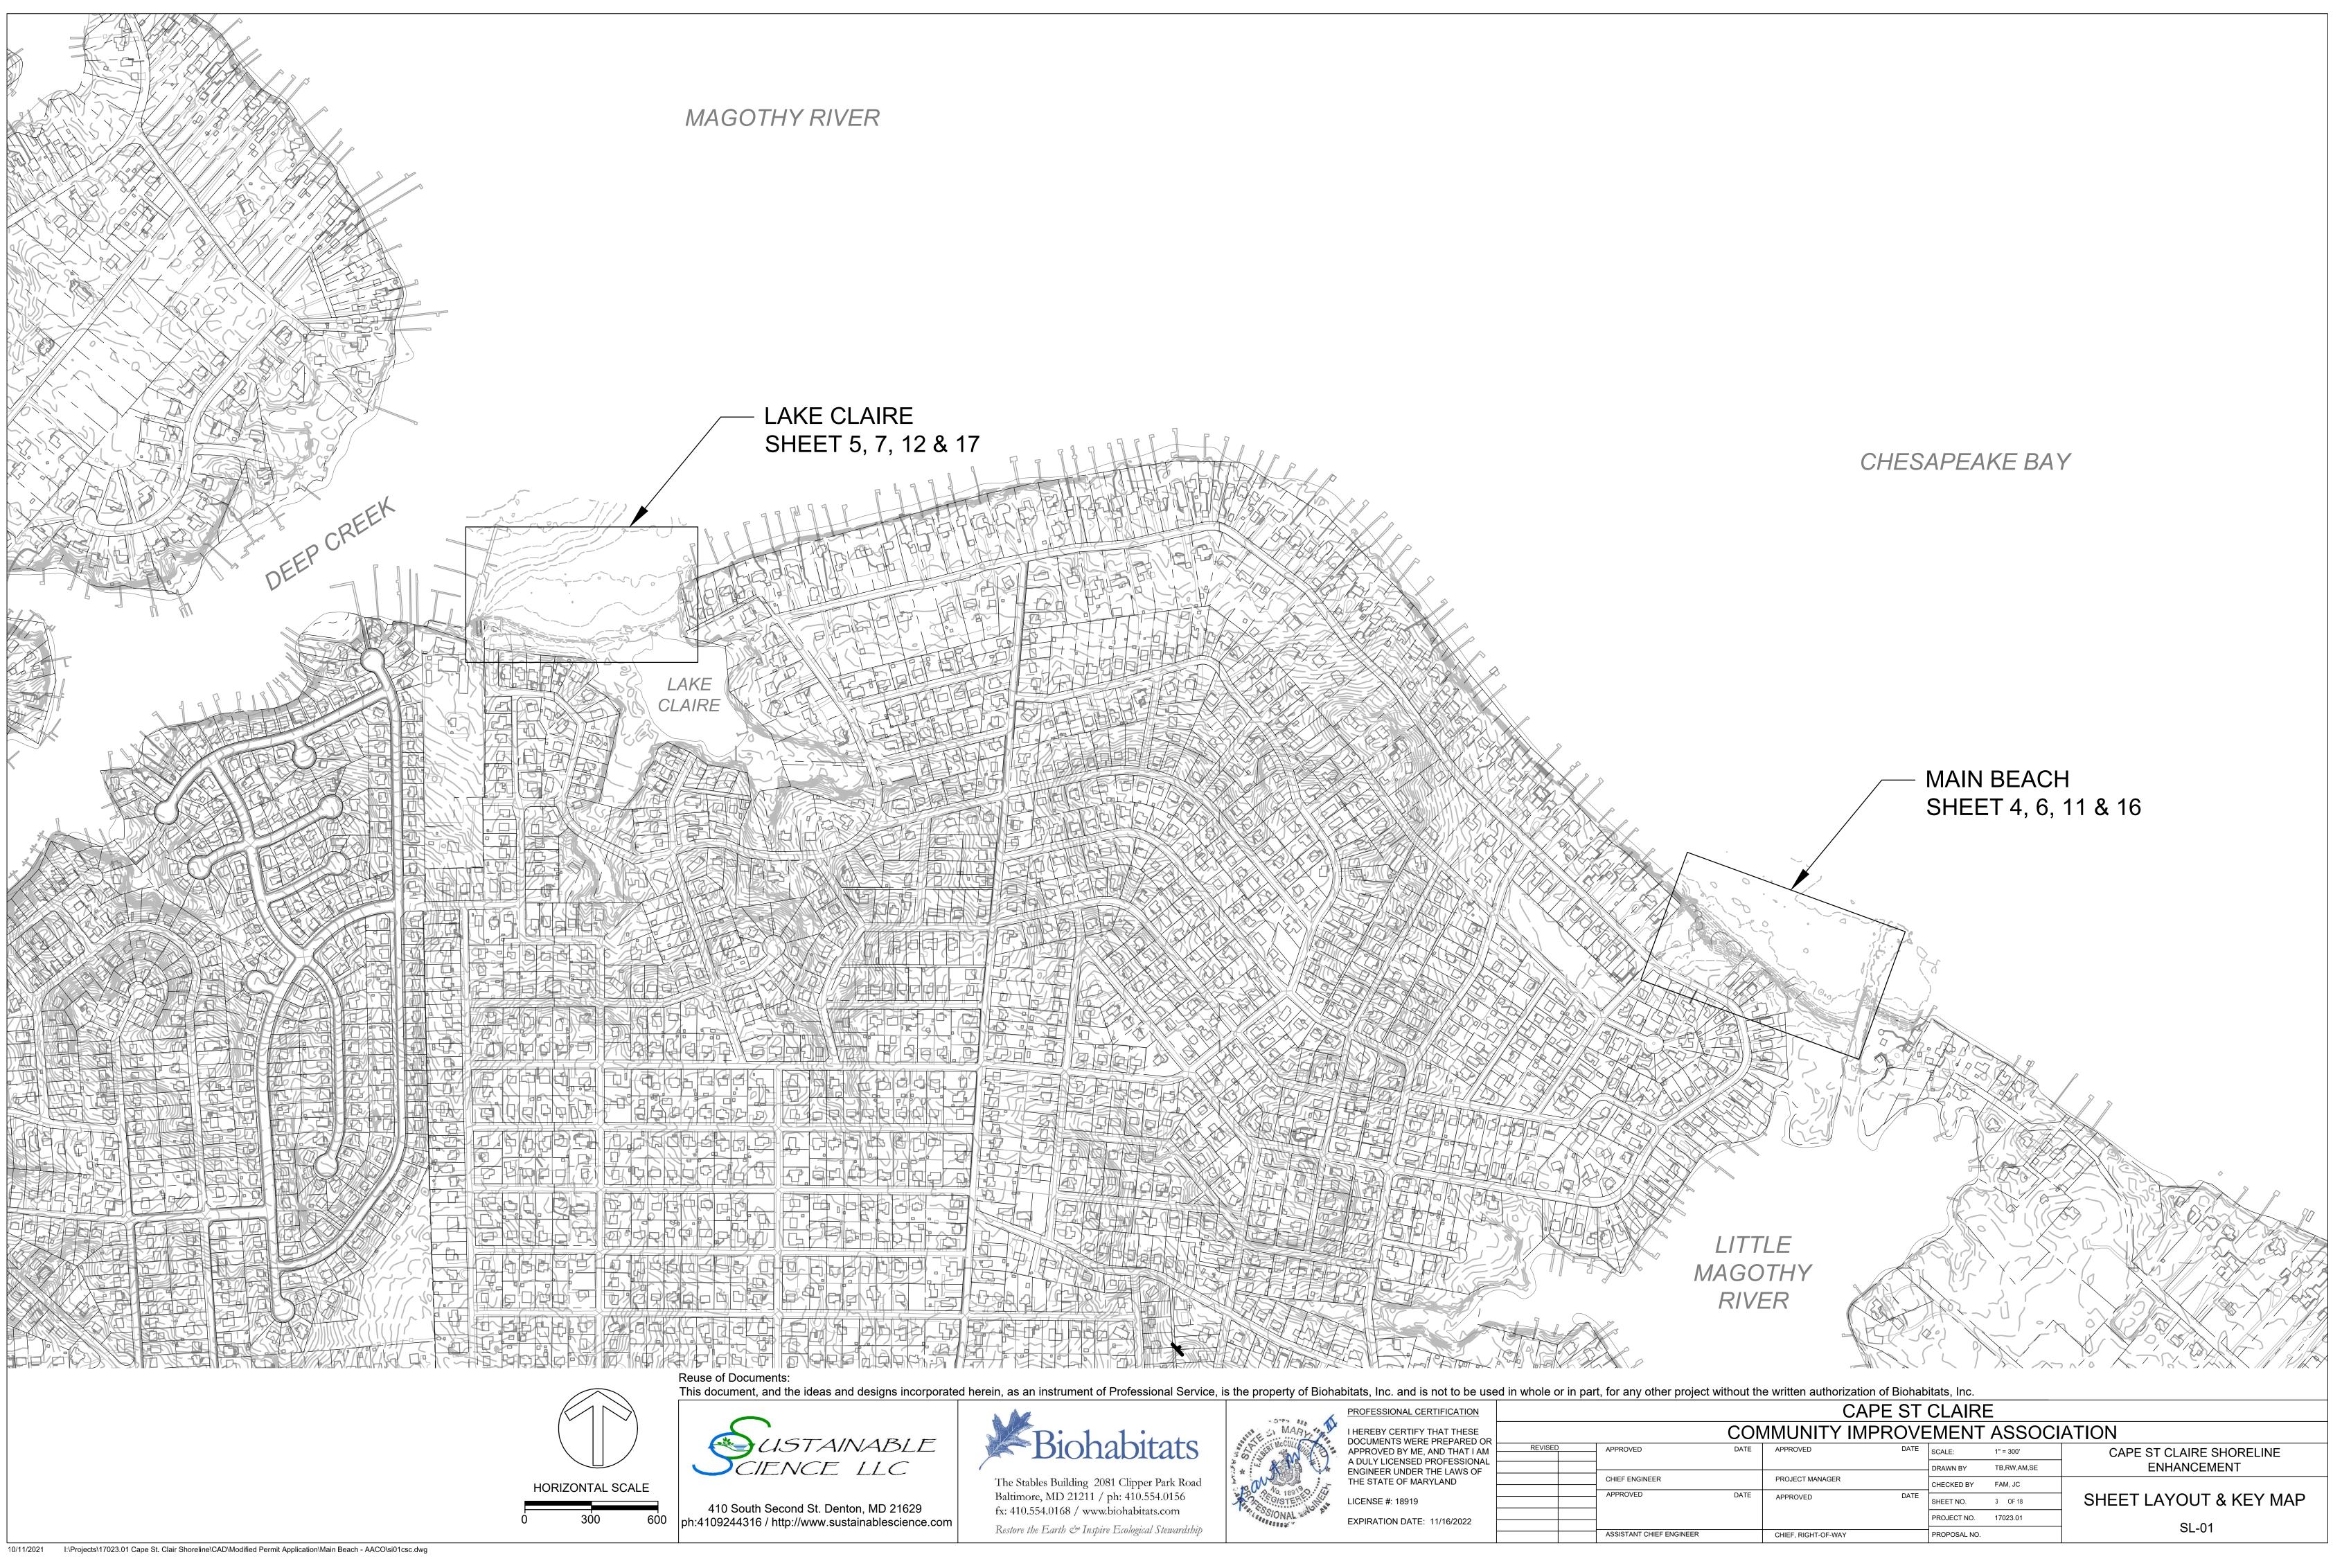



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	CHIEF
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	ASSIS

COMMUNITY IMPROVEMENT ASSOCIATION							
DATE	APPROVED	DATE	SCALE:	1" = 300'	CAPE ST CLAIRE SHORELINE		
			DRAWN BY	TB,RW,AM,SE	ENHANCEMENT		
	PROJECT MANAGER		CHECKED BY	FAM, JC			
DATE	APPROVED	DATE	SHEET NO.	3 OF 18	SHEET LAYOUT & KEY MAP		
			PROJECT NO.	17023.01			
	CHIEF, RIGHT-OF-WAY		PROPOSAL NO.		SL-01		
	DATE	DATE APPROVED PROJECT MANAGER DATE APPROVED	DATE APPROVED DATE PROJECT MANAGER DATE APPROVED DATE	DATE APPROVED DATE SCALE: PROJECT MANAGER CHECKED BY DATE APPROVED DATE SHEET NO. PROJECT NO.	DATE     APPROVED     DATE     SCALE:     1" = 300'       DRAWN BY     TB,RW,AM,SE       PROJECT MANAGER     CHECKED BY     FAM, JC       DATE     APPROVED     DATE     SHEET NO.     3 OF 18       PROJECT NO.     17023.01		

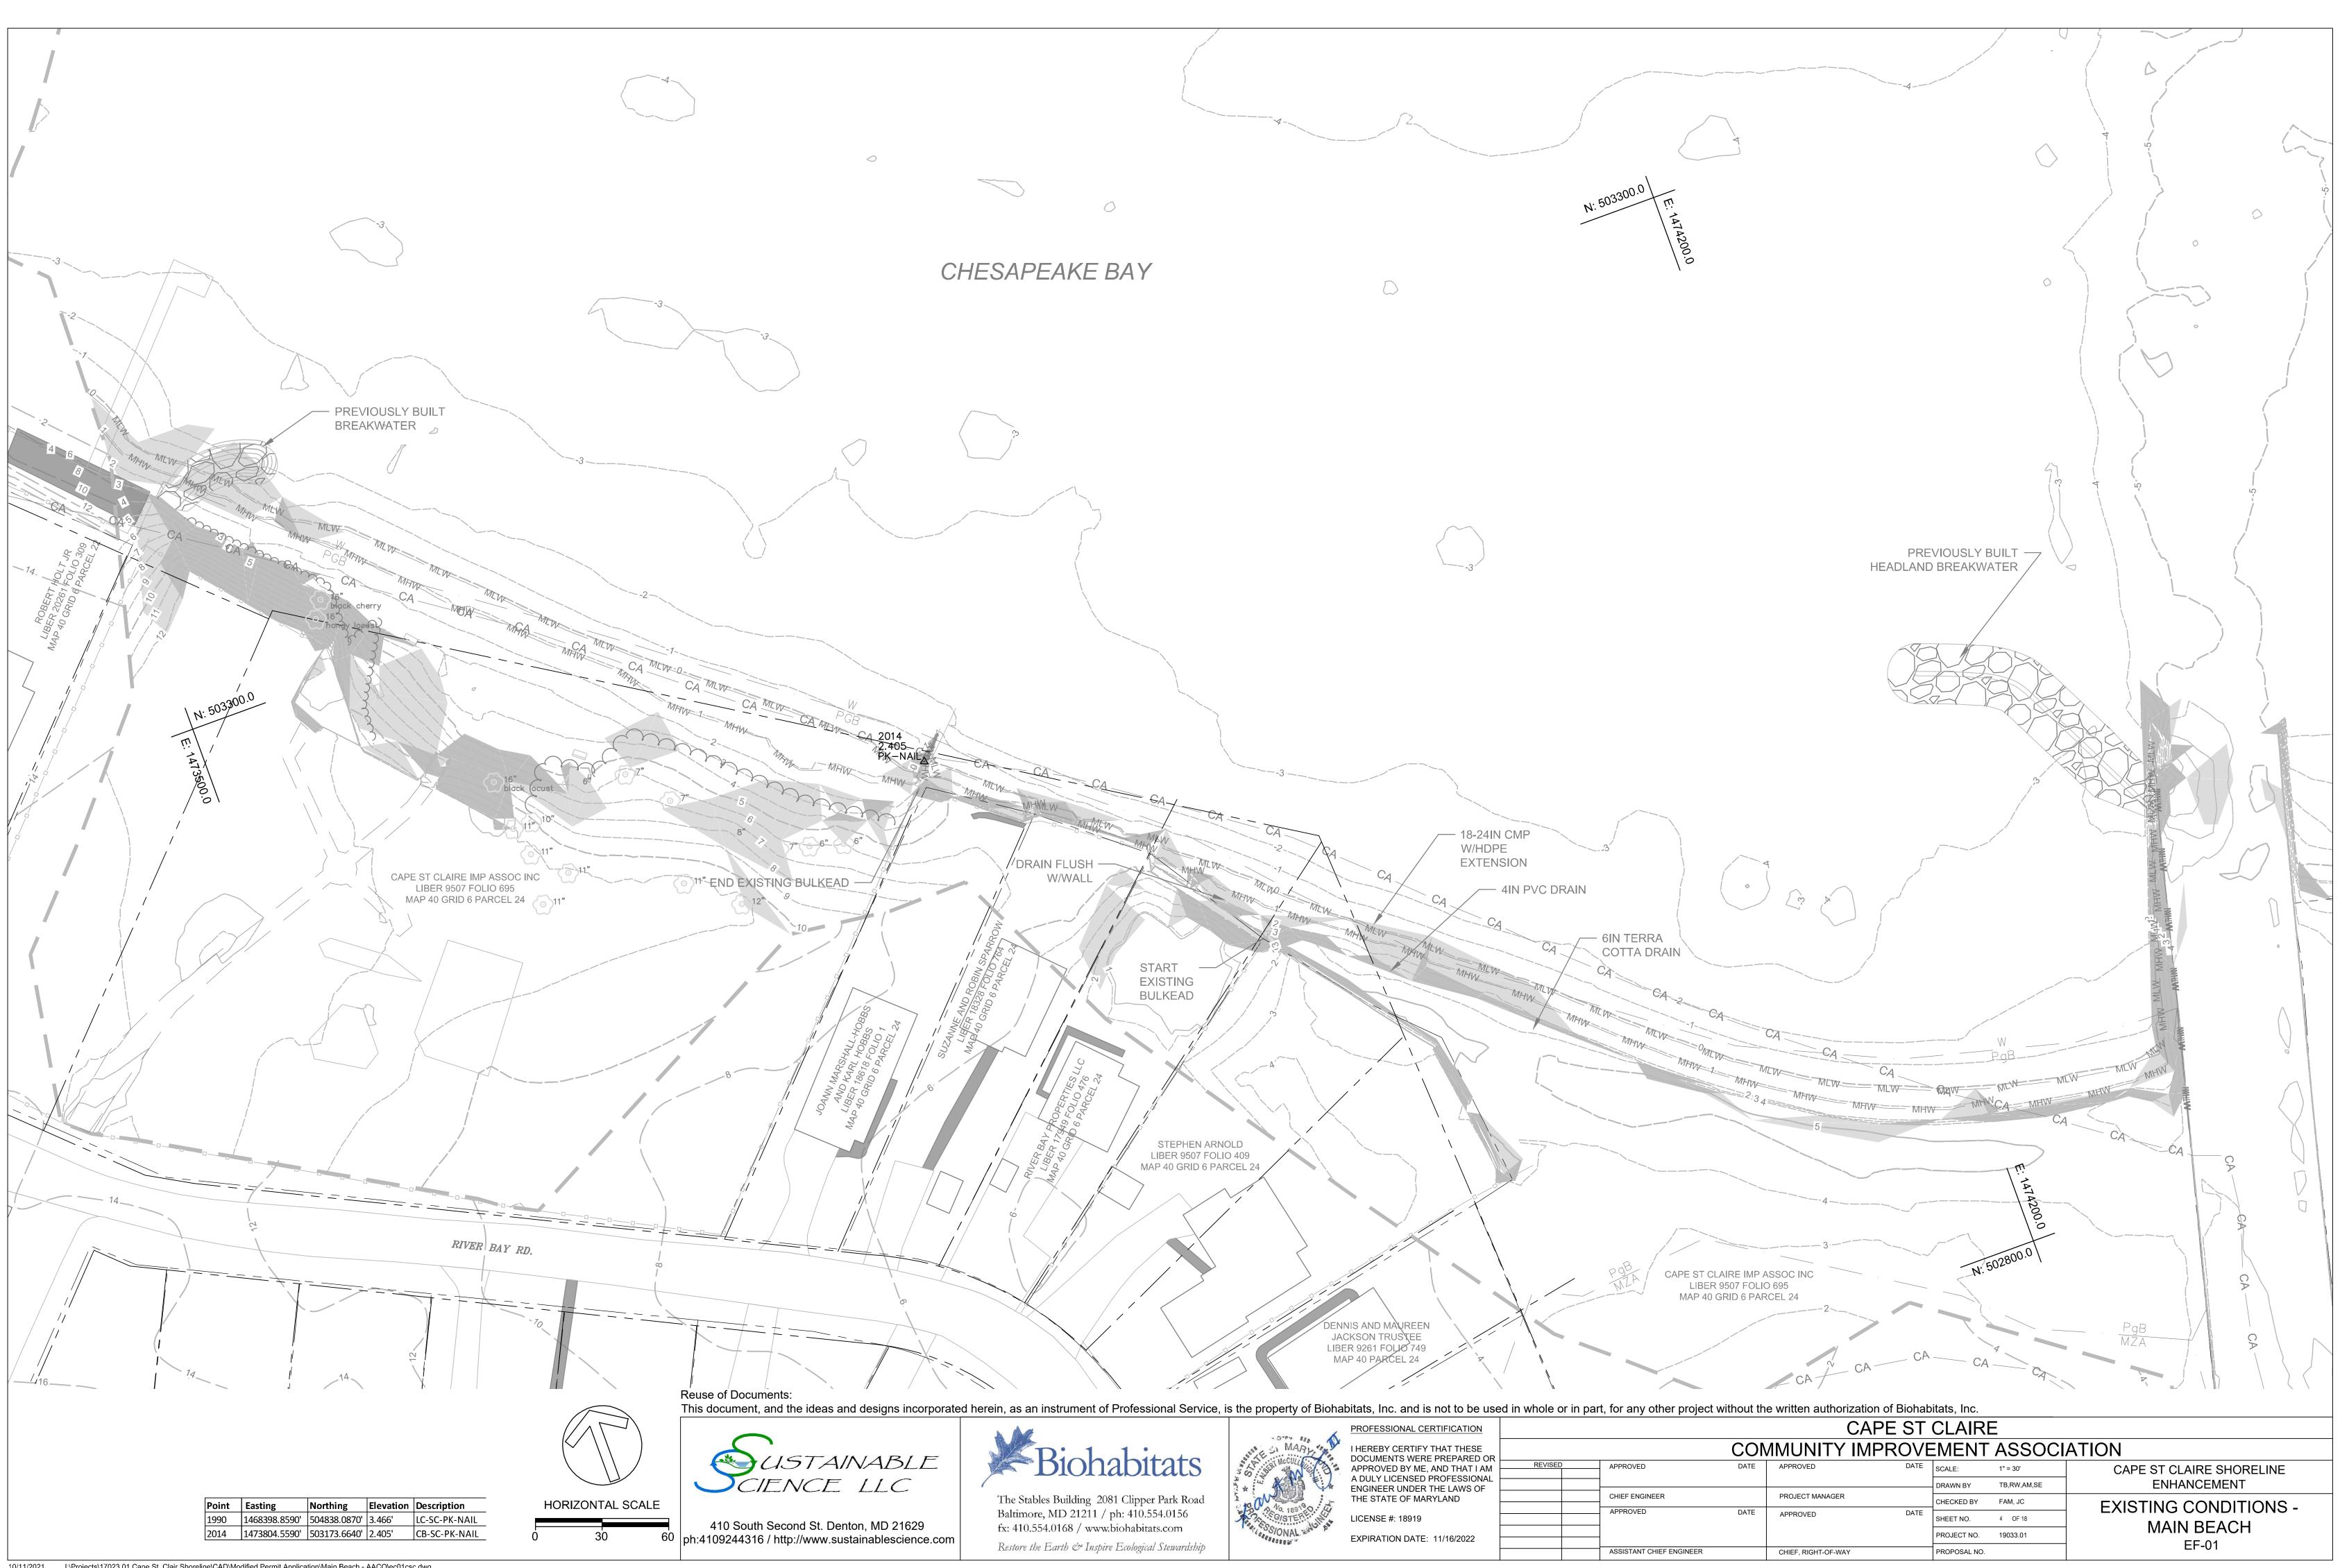



10/11/2021 I:\Projects\17023.01 Cape St. Clair Shoreline\CAD\Modified Permit Application\Main Beach - AACO\ec01csc.dwg

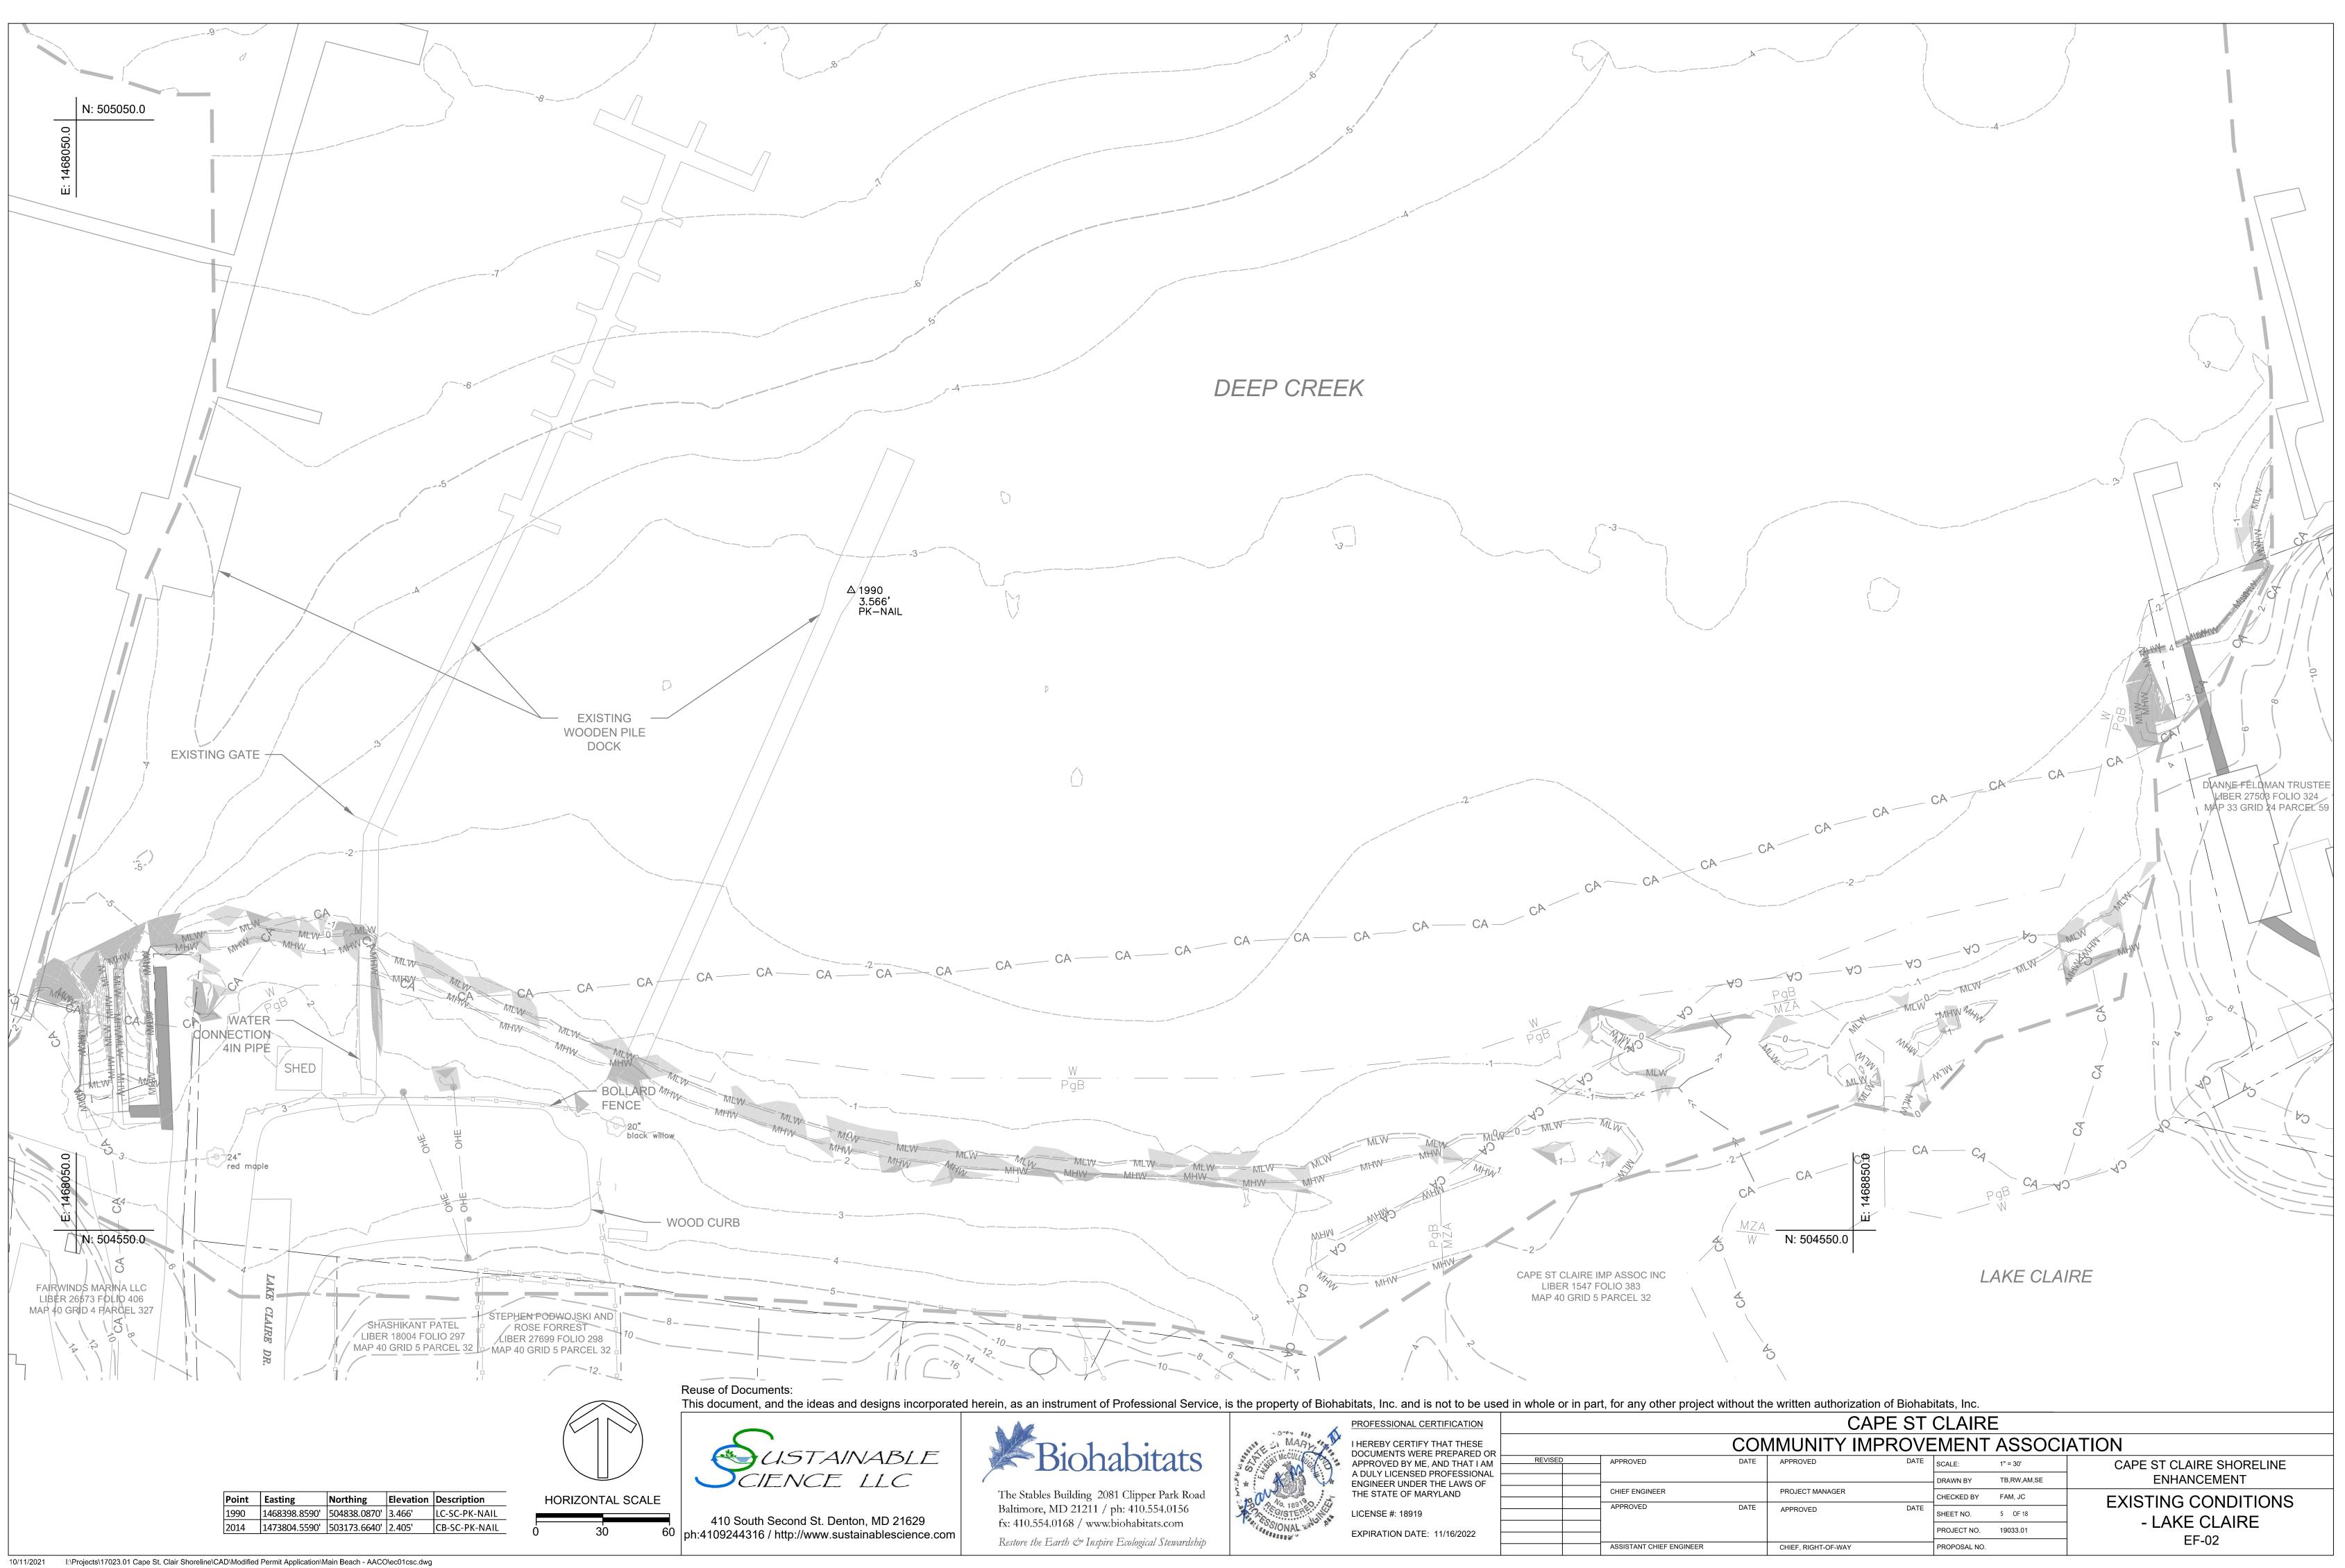

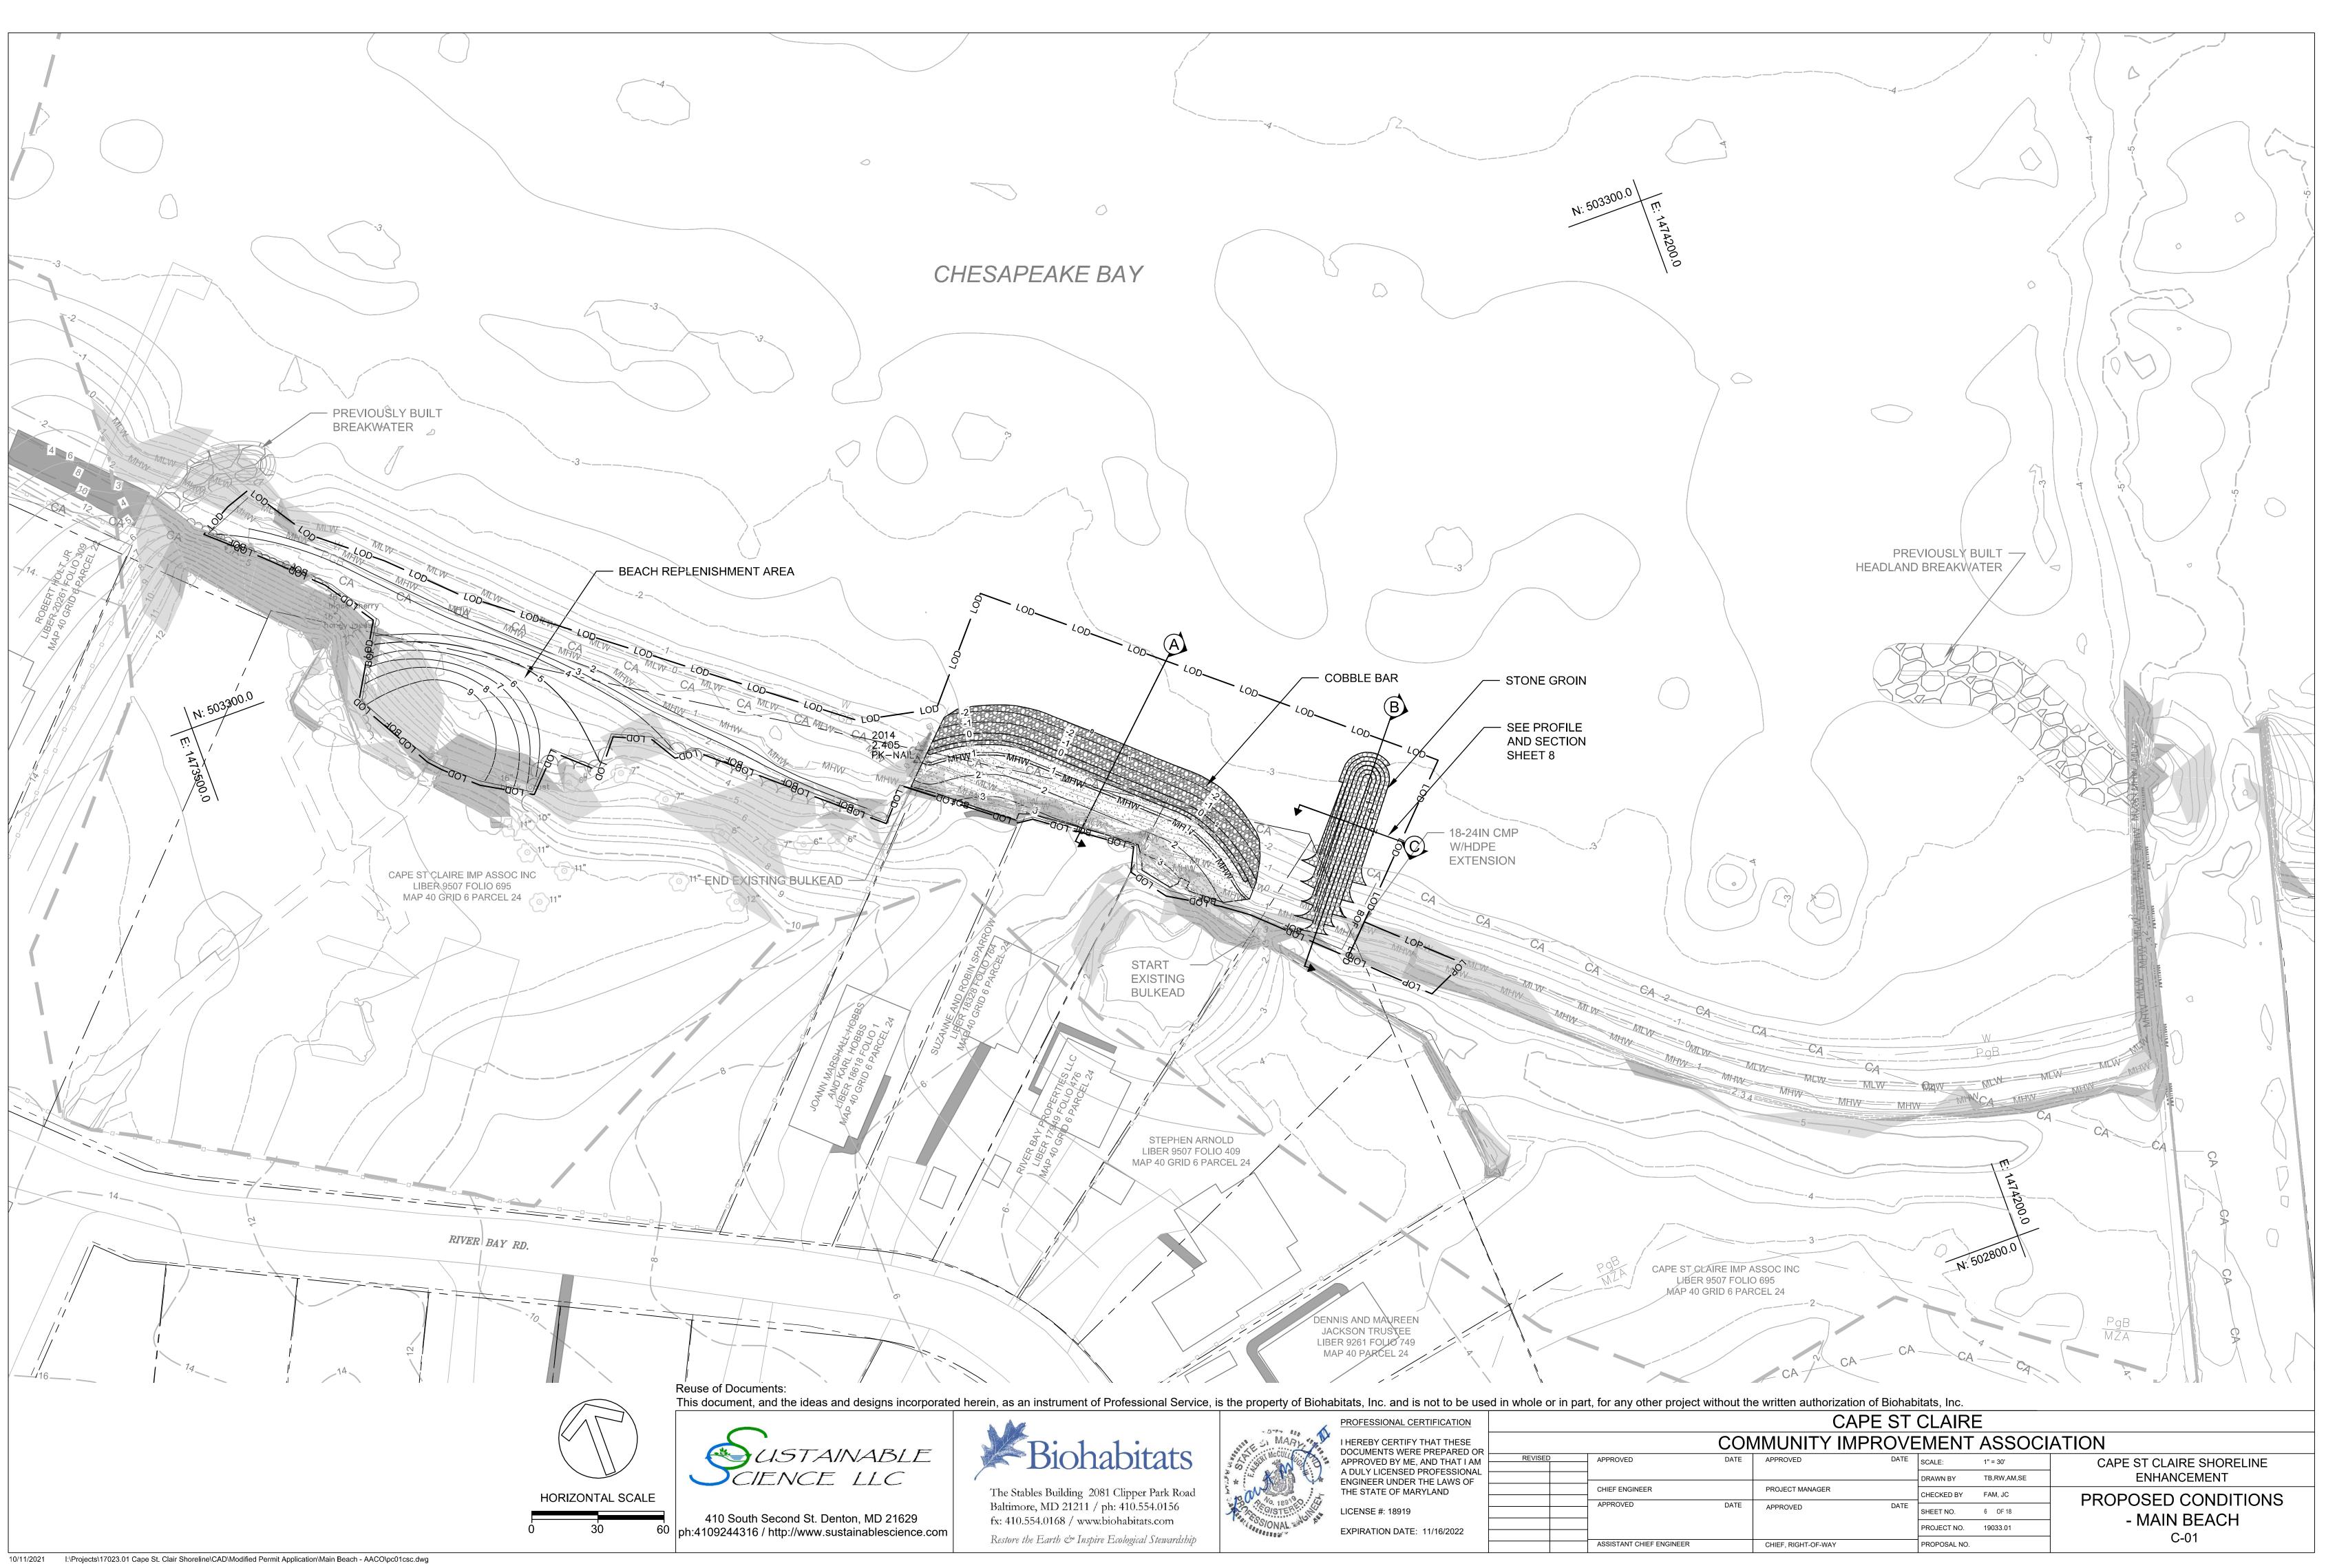


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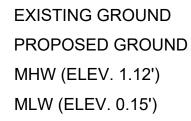


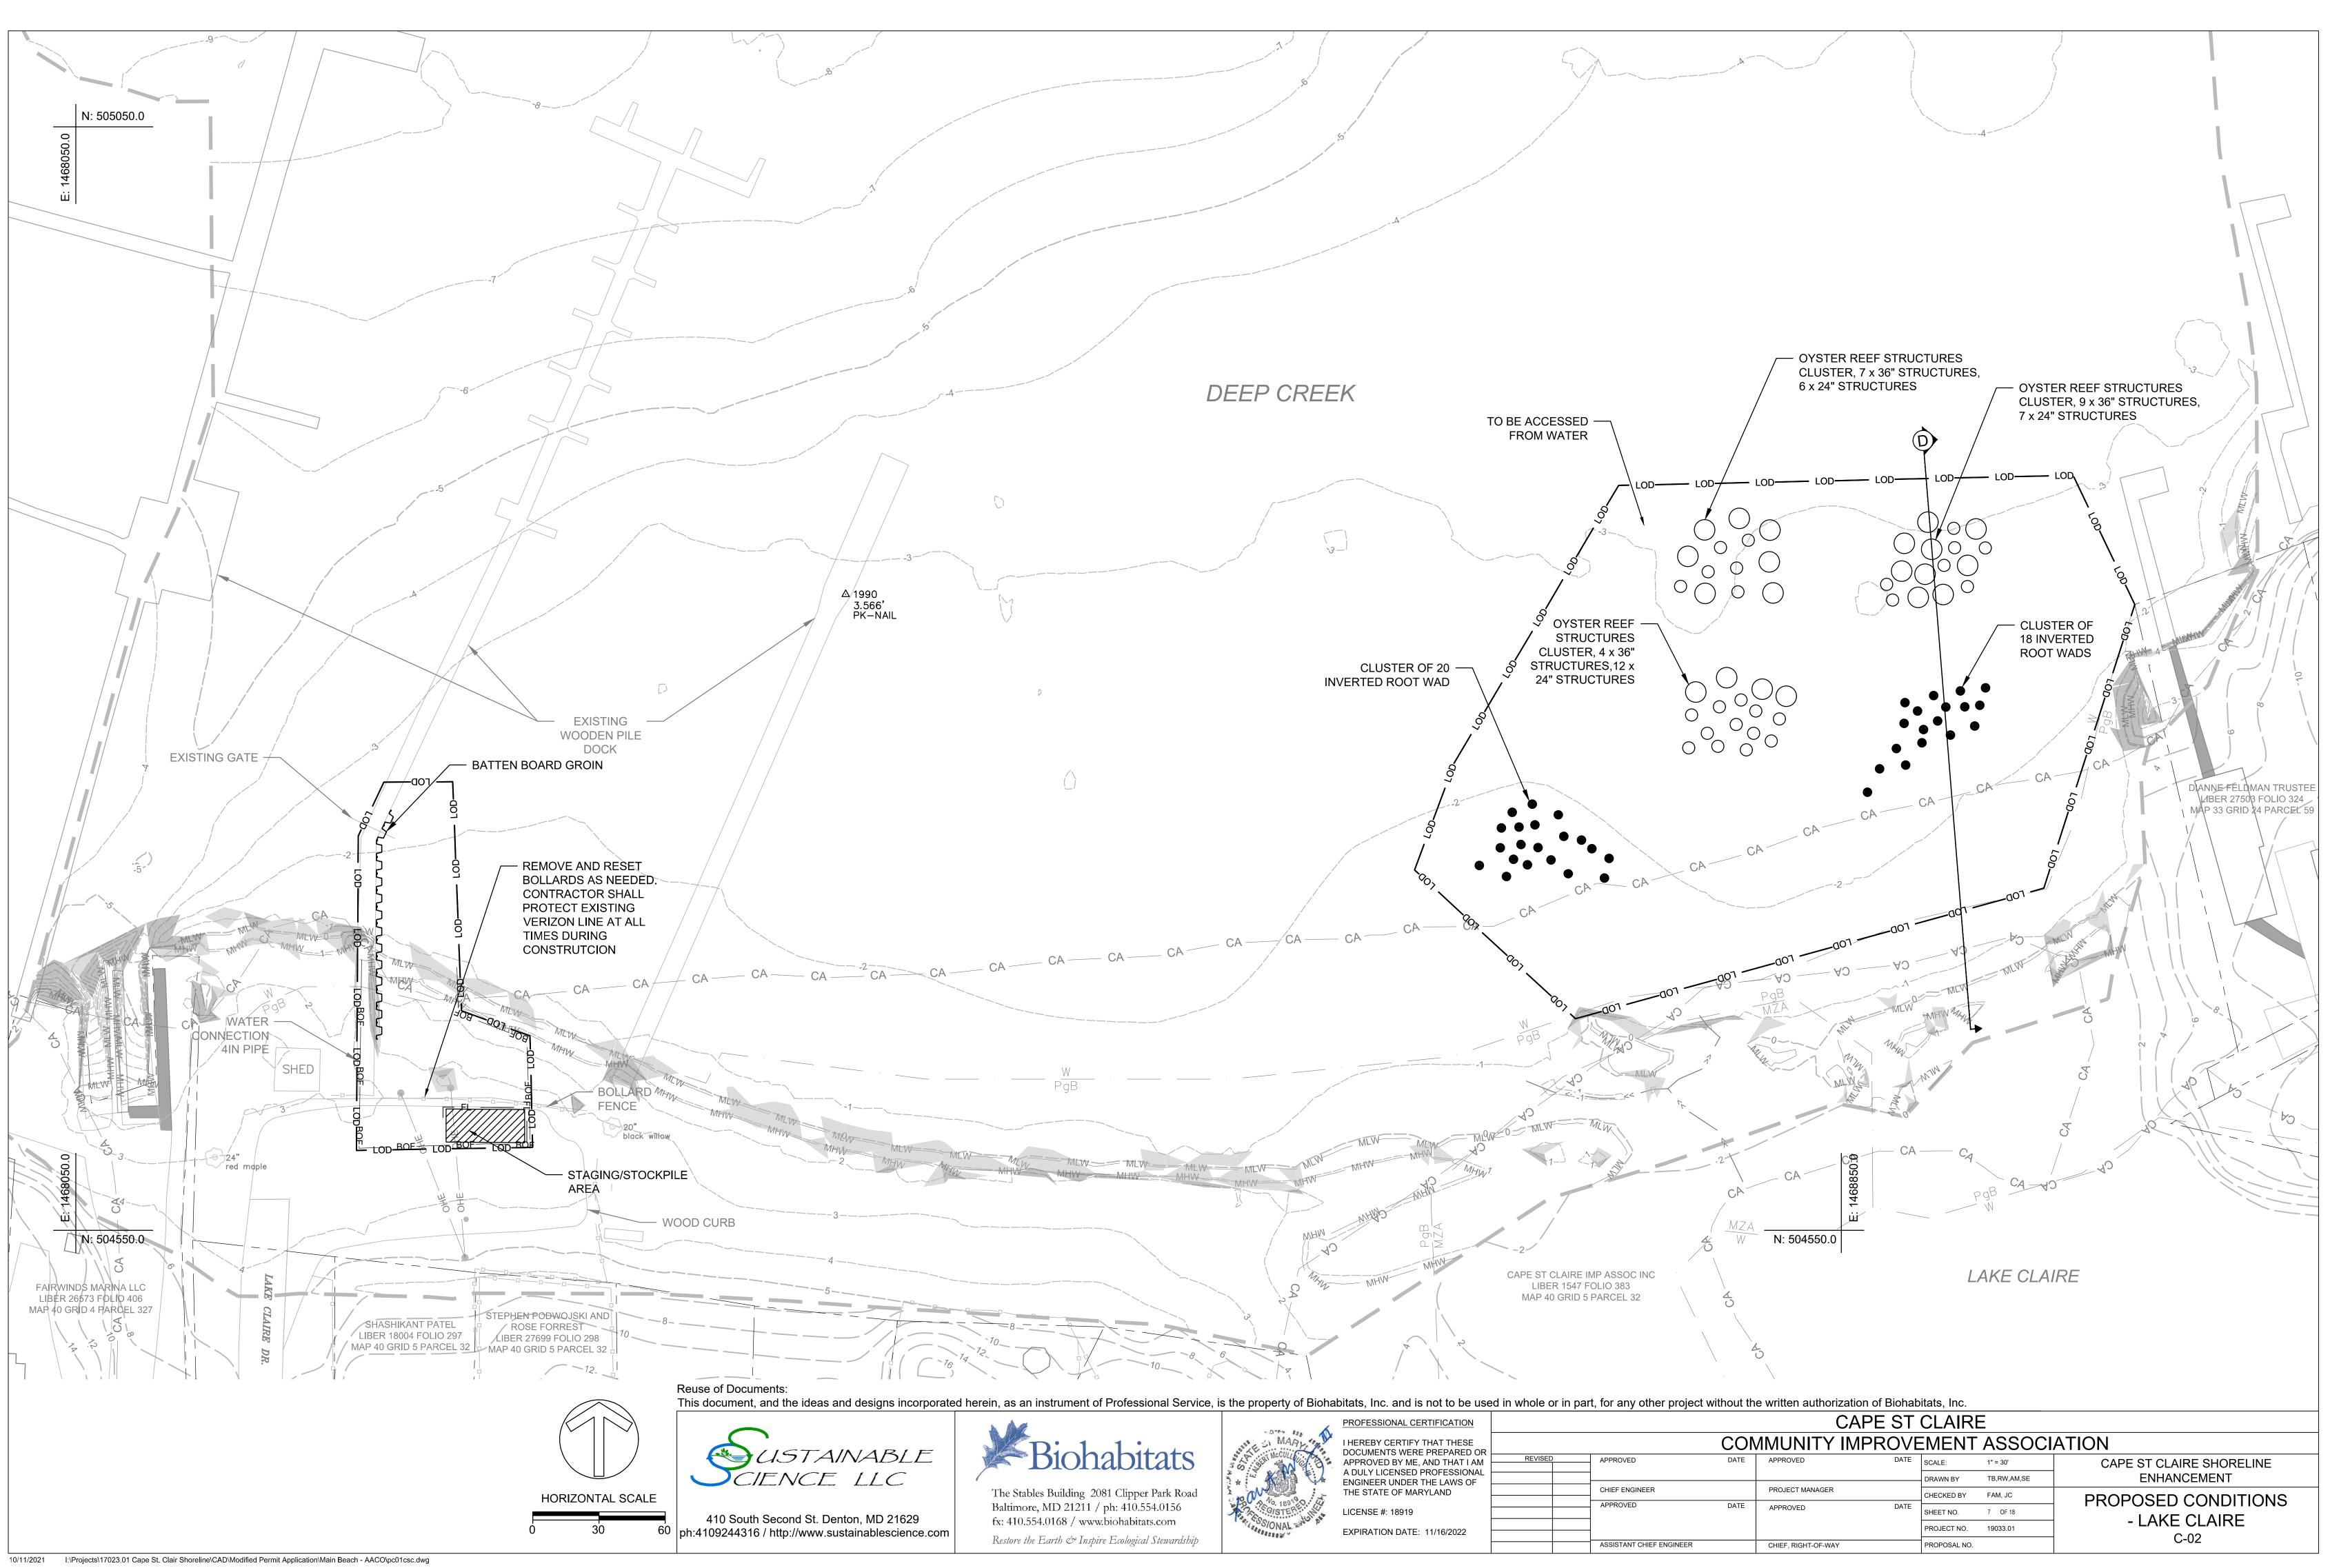

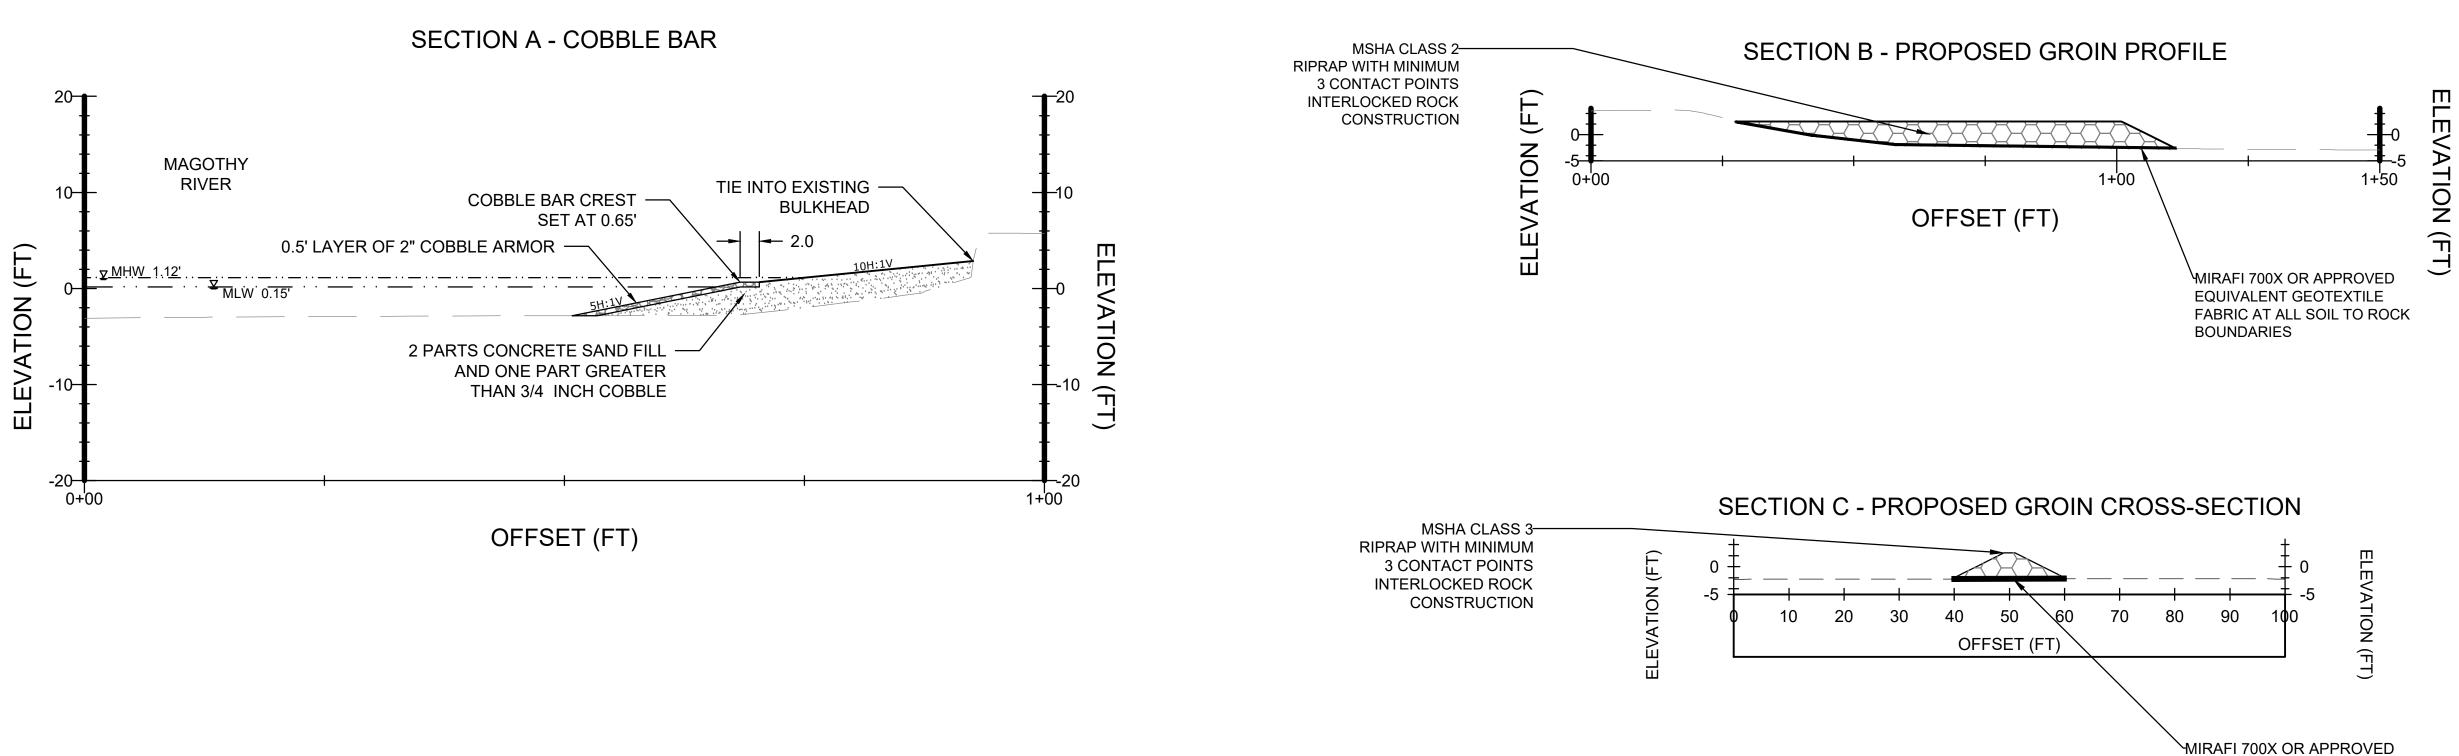



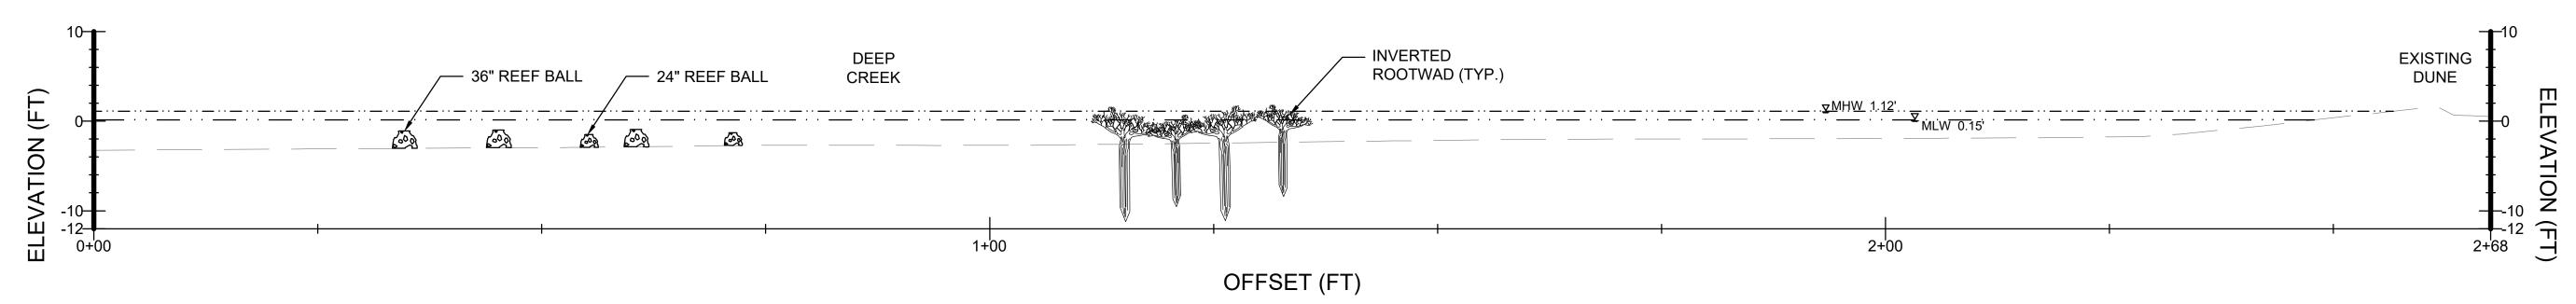



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HORIZONTAL SCALE


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## SECTION D - ROOTWAD AND REEF BALL PLACEMENT

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Restore the Earth & Inspire Ecological Stewardship



ENGINEER UNDER THE LAWS OF THE STATE OF MARYLAND LICENSE #: 18919

EXPIRATION DATE: 11/16/2022
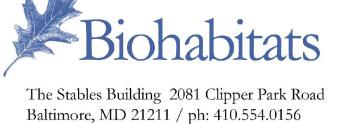
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A DULY LICENSED PROFESSIONAL

APPROVED BY ME, AND THAT I AM

APPR CHIEF APPR


MIRAFI 700X OR APPROVED EQUIVALENT GEOTEXTILE FABRIC AT ALL SOIL TO ROCK BOUNDARIES

any other project without the written authorization of Biohabitats, Inc										
	any	other	project	without	the	written	authorization	of	Biohabitats,	Inc.

CAPE ST CLAIRE								
COMMUNITY IMPROVEMENT ASSOCIATION								
DATE	APPROVED	DATE	SCALE:	1" = 10'	CAPE ST CLAIRE SHORELINE			
			DRAWN BY	TB,RW,AM,SE	ENHANCEMENT			
	PROJECT MANAGER		CHECKED BY	FAM, JC				
DATE	APPROVED	DATE	SHEET NO.	8 OF 18	CROSS SECTIONS			
			PROJECT NO.	19033.01	00.01			
	CHIEF, RIGHT-OF-WAY		PROPOSAL NO.		CS-01			
	DATE	COMMUNITY IM         DATE       APPROVED         PROJECT MANAGER         DATE       APPROVED	DATE       APPROVED       DATE         PROJECT MANAGER       DATE         DATE       APPROVED       DATE	COMMUNITY IMPROVEMENT         DATE       APPROVED       DATE       SCALE:         DATE       PROJECT MANAGER       DRAWN BY         DATE       APPROVED       CHECKED BY         DATE       APPROVED       DATE         SHEET NO.       PROJECT NO.	COMMUNITY IMPROVEMENT ASSOC         DATE       APPROVED       DATE       SCALE:       1" = 10'         DATE       PROJECT MANAGER       DRAWN BY       TB,RW,AM,SE         DATE       APPROVED       DATE       CHECKED BY       FAM, JC         DATE       APPROVED       DATE       SHEET NO.       8 OF 18         PROJECT NO.       19033.01       PROJECT NO.       19033.01			



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ONAL.

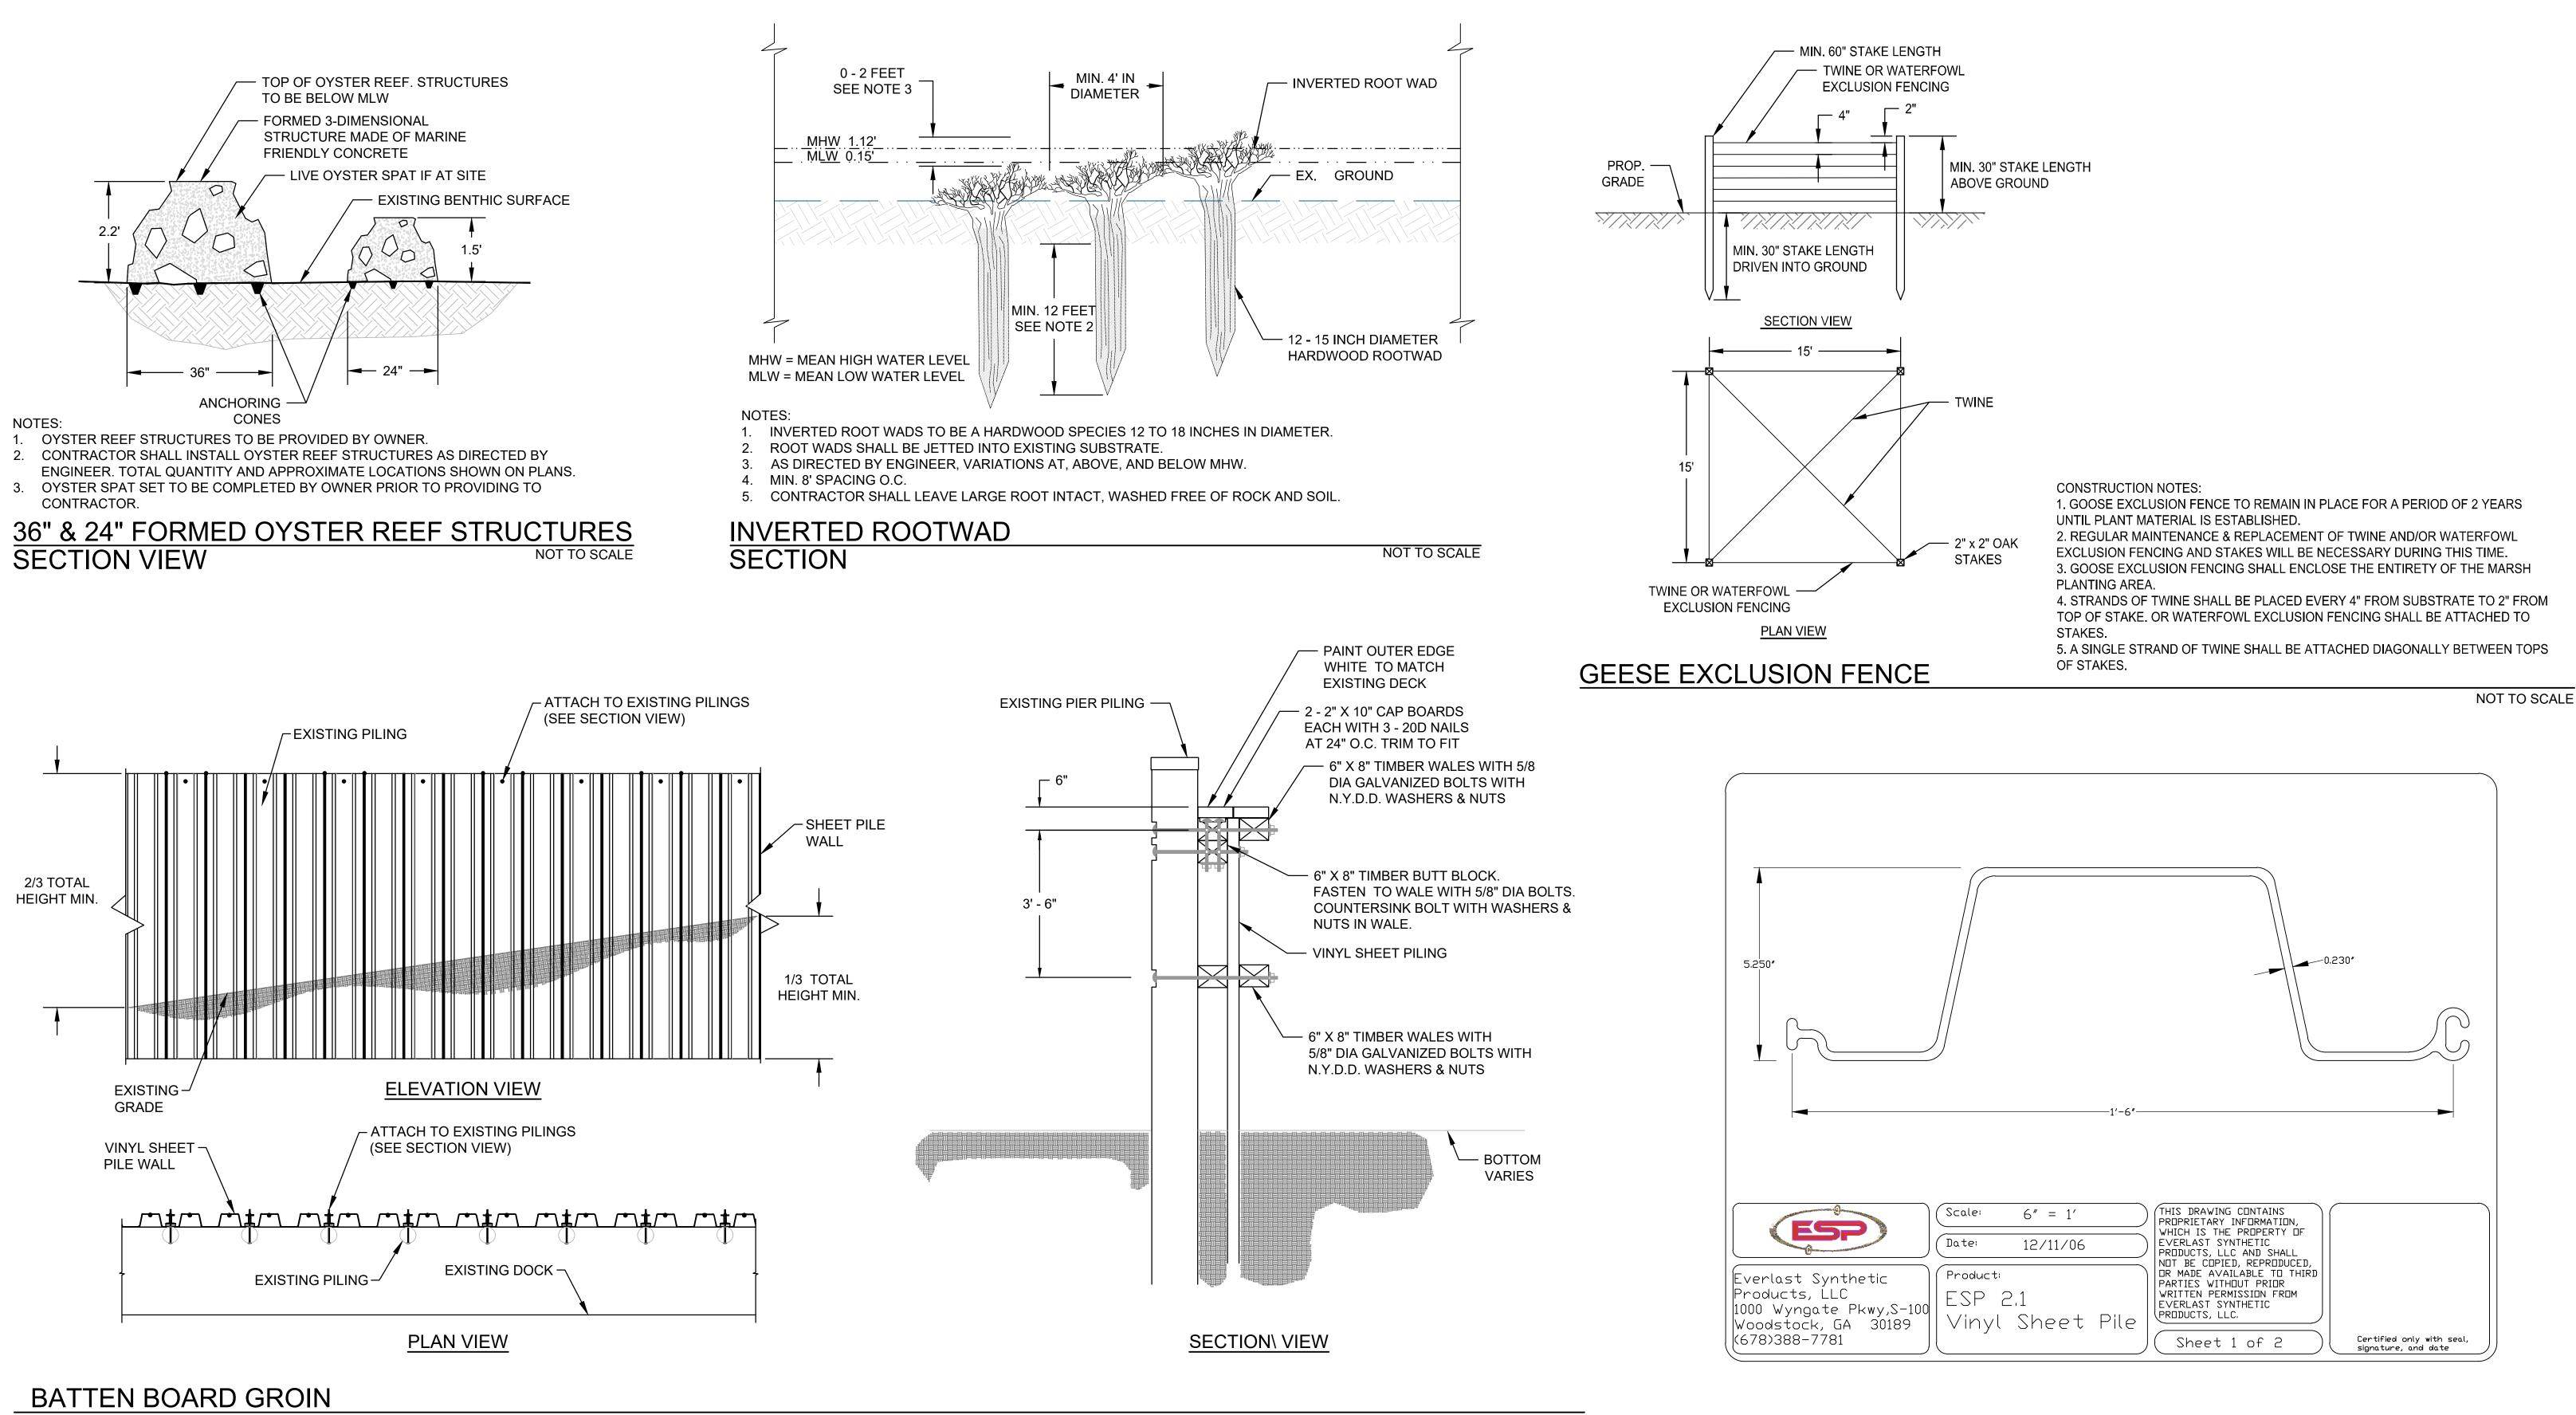THE STATE OF MARYLAND LICENSE #: 18919

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APPROVED BY ME, AND THAT I AM

CHIE

		ate: 1		/		, LLC AND SHALL						
st Synthetic ts, LLC ngate Pkwy,S ock, GA 3018 8-7781	_100 E	roduct: ISP 2,1 /inyl S		Pile	DR MADE PARTIES WRITTEN EVERLAST PRODUCTS	DPIED, REPRODUCED, AVAILABLE TO THIRI WITHOUT PRIOR PERMISSION FROM SYNTHETIC , LLC.		Certified onl signature, a	y with seal, nd date			
										9		
any other project	without th	e written aut										
iny other project			CAP	E ST	CLAIR							
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			CAP	E ST	CLAIR			N CAPE ST	CLAIRE	SHORE	ELINE	
DVED	CON	APPROVED	CAP Y IMP	e st Rove	CLAIR EMENT	ASSOCIA		CAPE ST	CLAIRE S		ELINE	
OVED	DATE	MMUNIT	CAP Y IMP	e st Rove	CLAIR EMENT SCALE:	ASSOCIA NTS		CAPE ST			ELINE	
OVED F ENGINEER	CON	APPROVED	CAP Y IMP	e st Rove	CLAIR EMENT SCALE: DRAWN BY	ASSOCIA NTS TB,RW,AM,SE		CAPE ST EN		IENT	ELINE	
any other project	DATE	APPROVED PROJECT MANA	CAP Y IMP	E ST ROVE DATE	CLAIR MENT SCALE: DRAWN BY CHECKED BY	ASSOCIA NTS TB,RW,AM,SE FAM, JC		CAPE ST EN	IHANCEM	IENT _S	ELINE	

# SEQUENCE OF CONSTRUCTION

## NOTES:

- 1. THE CONTRACTOR (SHORELINE DESIGN) SHALL CONDUCT AN ON-SITE PRE-CONSTRUCTION MEETING WITH THE SEDIMENT CONTROL INSPECTOR WITH ANNE ARUNDEL COUNTY DEPARTMENT OF INSPECTIONS AND PERMITS AND THE ENGINEER/DESIGNATED SPECIALIST TO REVIEW THE LIMITS OF DISTURBANCE, EROSION AND SEDIMENT CONTROL REQUIREMENTS, AND THE SEQUENCE OF CONSTRUCTION
- THE CONTRACTOR SHALL NOTIFY THE ANNE ARUNDEL COUNTY DEPARTMENT OF 2. INSPECTIONS AND PERMITS (410-222-7780) AT LEAST 48 HOURS BEFORE COMMENCING WORK. WORK MAY NOT COMMENCE UNTIL THE PERMITTEE OR THE RESPONSIBLE PERSONNEL HAVE MET ON SITE WITH THE SEDIMENT AND EROSION CONTROL INSPECTOR TO REVIEW THE APPROVED PLANS.
- CONTACT NICOLE VOELKER AT 410-962-1847 OR NICOLE.M.VOELKER@USACE.ARMY.MIL 3. WITHIN TWO (2) WEEKS PRIOR TO COMMENCING THE AUTHORIZED WORK, AND UPON COMPLETION OF THE WORK.
- 4. THE CONTRACTOR SHALL NOTIFY MDE COMPLIANCE INSPECTOR AT 410-537-3510 AT LEAST 24 HOURS BEFORE COMMENCING WORK.
- 5. THE CONTRACTOR SHALL CALL MISS UTILITY AT 1-800-277-7777 A MINIMUM OF 48 HOURS BEFORE STARTING CONSTRUCTION. ALL EXISTING UTILITIES MUST BE MARKED IN THE FIELD PRIOR TO CONSTRUCTION. THE CONTRACTOR IS RESPONSIBLE FOR ANY DAMAGE TO EXISTING UTILITIES THAT MAY OCCUR AS A RESULT OF THE CONSTRUCTION. DAMAGED UTILITIES ARE TO BE IMMEDIATELY REPORTED TO BOTH THE UTILITY OWNER AND PROJECT ENGINEER/DESIGNATED SPECIALIST. ANY DAMAGE TO EXISTING STRUCTURES. INCLUDING SEWER PIPES/MANHOLES AND STORM DRAIN PIPES/STRUCTURES, SHALL BE REPAIRED TO THE UTILITY OWNER'S SATISFACTION BY THE CONTRACTOR AT HIS/HER OWN EXPENSE.
- CONSTRUCTION ACTIVITIES, INCLUDING THE INSTALLATION OF EROSION AND SEDIMENT CONTROL MEASURES, SHALL NOT BEGIN UNTIL ALL REQUIRED EASEMENTS AND RIGHT-OF-WAYS HAVE BEEN OBTAINED. CONSTRUCTION SHALL NOT BEGIN UNTIL ALL SEDIMENT AND EROSION CONTROL MEASURES HAVE BEEN INSTALLED AND APPROVED BY THE PROJECT ENGINEER/DESIGNATED SPECIALIST AND THE SEDIMENT CONTROL INSPECTOR.
- THE CONTRACTOR SHALL CONTACT NEARBY ACTIVE OYSTER LEASEHOLDERS A MINIMUM 7 OF 30 DAYS PRIOR TO COMMENCEMENT OF CONSTRUCTION. LEASEHOLDER CONTACT INFORMATION CAN BE OBTAINED FROM MARYLAND DNR, AQUACULTURE DIVISION, FISHERIES SERVICE (410-260-8252). CARE SHALL BE TAKEN DURING ALL PHASES OF CONSTRUCTION, INCLUDING ANCHORAGE OF SHALLOW WATER BARGE OR SIMILAR VESSELS. TO AVOID DISTURBANCE TO AND/OR SEDIMENTATION OF ADJACENT OYSTER LEASES.
- THE ANNE ARUNDEL COUNTY DEPARTMENT OF INSPECTION AND PERMITS WILL BE 8. NOTIFIED UPON THE START OF EACH PHASE OF CONSTRUCTION. UPON APPROVAL OF THE COUNTY INSPECTOR, THE CONTRACTOR MAY BEGIN CONSTRUCTION ACTIVITIES. CONSTRUCTION SHALL BE DONE IN ACCORDANCE WITH THE APPROVED SEQUENCE OF CONSTRUCTION AND PROPOSED CONDITIONS, PROJECT SPECIFICATIONS, AND EROSION AND SEDIMENT CONTROL STANDARD DETAILS AND NOTES.
- THE LIMITS OF DISTURBANCE (LOD) SHOWN ON THE PLANS ENCOMPASSES ALL DISTURBANCE ACTIVITIES RELATED TO CONSTRUCTION ACCESS AND SHORELINE IMPROVEMENTS. PLANTING ACTIVITIES ARE DELIMITED BY THE LIMITS OF PLANTING (LOP): NO LAND DISTURBANCE IS PROPOSED WITHIN THE LOP. ACCESS FOR ALL PLANTING WORK SHALL ALSO OCCUR BY BARGE.
- 10. SITES 1 AND 2 MAY BE CONSTRUCTED CONCURRENTLY OR ONE AT A TIME; SITE 2 MAY BE **CONSTRUCTED BEFORE SITE 1.**
- 11. THROUGHOUT THE TIMEFRAME OF CONSTRUCTION OF THE SHORELINE IMPROVEMENTS, THE FOLLOWING APPLIES
- A. NO WORK IS ALLOWED FROM NOVEMBER 15TH TO MARCH 1ST OF ANY YEAR TO MINIMIZE IMPACT TO WATERFOWL.
- 11. FOLLOWING INITIAL SOIL DISTURBANCE OR RE-DISTURBANCE, PERMANENT OR TEMPORARY STABILIZATION SHALL BE COMPLETED WITHIN:
  - A. THREE CALENDAR DAYS FOR THE SURFACE OF ALL PERIMETER CONTROLS, DIKES, SWALES, DITCHES, PERIMETER SLOPES, AND ALL SLOPES GREATER THAN THREE HORIZONTAL TO ONE VERTICAL (3:1);
  - B. SEVEN DAYS FOR ALL OTHER DISTURBED OR GRADED AREAS ON PROJECT SITE

EROSION AND SEDIMENT CONTROL SETUP (7 DAYS):

- 1. THE CONTRACTOR SHALL STAKE OUT THE NECESSARY LOD. (2 DAYS)
- 2. THE CONTRACTOR SHALL CONDUCT A PRE-CONSTRUCTION MEETING ONSITE WITH THE SEDIMENT CONTROL INSPECTOR WITH ANNE ARUNDEL COUNTY DEPARTMENT OF INSPECTIONS AND PERMITS AND THE PROJECT ENGINEER/DESIGNATED SPECIALIST TO REVIEW THE CONSTRUCTION ACCESS, EROSION AND SEDIMENT CONTROL REQUIREMENTS, AND THE SEQUENCE OF CONSTRUCTION. (1 DAY)

- 4
- 5

- (1 DAY)
- 5 DAYS).
- 6. INSTRUCTIONS.

- AS SHOWN ON THE PLANS. (1 DAY)
- 3.

### PLANTING (3 DAYS):

- AND DETAILS. (3 DAYS)
- DISPLAYED ON THE PLANTING PLAN.
- 3.

Reuse of Documents:



3. THE CONTRACTOR SHALL INSTALL BLAZE ORANGE FENCING AND EROSION CONTROL MEASURES AS SHOWN ON THE EROSION & SEDIMENT CONTROL PLANS. (3 DAYS)

PRIOR TO COMMENCING WORK, THE SEDIMENT CONTROL INSPECTOR WILL BE NOTIFIED ONCE SEDIMENT CONTROL MEASURES ARE INSTALLED. UPON COMPLETION OF SEDIMENT CONTROL MEASURE INSTALLATION AND WITH APPROVAL OF THE SEDIMENT CONTROL INSPECTOR, THE CONTRACTOR MAY BEGIN GRADING OPERATIONS (1 DAY).

UPON THE COMPLETION OF CONSTRUCTION AND WHEN THE SITE IS 95% STABILIZED EITHER VEGETATIVELY OR MECHANICALLY, REMOVE SEDIMENT CONTROL MEASURES WITH THE SEDIMENT CONTROL INSPECTOR'S APPROVAL.

SITE 1: COBBLE BAR, STONE GROIN, AND BEACH REPLENISHMENT (24 DAYS)

1. ACCESS FOR CONSTRUCTION OF THE COBBLE BAR, STONE GROIN, AND BEACH REPLENISHMENT AREAS SHALL BE ACHIEVED FROM THE WATER VIA BARGE OR EQUIVALENT EQUIPMENT. THE CONTRACTOR SHALL TAKE CARE TO AVOID ALL ACTIVE BOATING ROUTES DURING CONSTRUCTION. THE CONTRACTOR IS RESPONSIBLE FOR OBTAINING ANY REQUIRED MARINE OR MOORING PERMITS.

THE CONTRACTOR SHALL CONDUCT WORK FROM THE BARGE. IF SHALLOW NEAR-SHORE DEPTHS INTERFERE WITH THE CONTRACTOR'S ABILITY TO REACH THE PROPOSED WORK AREAS. THE CONTRACTOR MAY MOVE MACHINERY OFF THE BARGE AND CONDUCT WORK FROM AREAS ADJACENT TO PROPOSED STRUCTURES.

THE CONTRACTOR SHALL STAKE OUT STRUCTURE LOCATIONS AS SHOWN ON THE PLANS.

PLACE DREDGE SAND MATERIAL AT THE DESIGNATED BEACH REPLENISHMENT AREA IN CONFORMANCE WITH THE GRADES SHOWN ON THE PLANS. DREDGE SAND MATERIAL TO BE INCLUDED IN THE COBBLE BAR MAY BE TEMPORARILY PLACED ON THE BEACH REPLENISHMENT AREA AS NEEDED AS LONG AS FINAL GRADES ARE ACHIEVED. (7 DAYS)

CONSTRUCT COBBLE BAR AND STONE GROIN CONCURRENTLY IN ACCORDANCE WITH THE PLANS. FOR THE COBBLE BAR, INSTALL SAND/COBBLE MIX TO THE EXTENTS AND DEPTHS SHOWN ON THE PLANS AND FACE WITH COBBLE ARMOR. FOR THE STONE GROIN, PLACE GEOTEXTILE FABRIC AND PLACE STONE FILL TO THE EXTENTS SHOWN ON THE PLANS (16

SEE PLANTING NOTES BELOW AND PLANTING PLAN AND DETAILS FOR PLANTING

SITE 2: OYSTER REEF/ROOT WAD STRUCTURES AND BATTEN BOARD GROIN (16 DAYS)

ACCESS FOR CONSTRUCTION OF THE OYSTER REEF AND ROOT WAD STRUCTURES SHALL BE ACHIEVED FROM THE WATER VIA BARGE OR EQUIVALENT EQUIPMENT. THE CONTRACTOR SHALL TAKE CARE TO AVOID ALL ACTIVE BOATING ROUTES DURING CONSTRUCTION. THE CONTRACTOR IS RESPONSIBLE FOR OBTAINING ANY REQUIRED MARINE OR MOORING PERMITS. ACCESS FOR THE BATTEN BOARD GROIN AREA SHALL BE ACHIEVED FROM THE LAND AS SHOWN ON THE PLANS.

THE CONTRACTOR SHALL STAKE OUT OR OTHERWISE IDENTIFY STRUCTURE LOCATIONS

INSTALL OYSTER REEF AND ROOT WAD STRUCTURES FROM THE BARGE AND BATTEN BOARD GROIN FROM THE LAND CONCURRENTLY IN ACCORDANCE WITH THE PLANS. THE CONTRACTOR SHALL TAKE CARE TO MINIMIZE IMPACTS TO TERRESTRIAL AREAS WITHIN THE LOD AT THE BATTEN BOARD GROIN INSTALLATION AREA. (15 DAYS)

1. UPON THE COMPLETION OF CONSTRUCTION ACTIVITIES, STABILIZE ANY REMAINING DISTURBED AREAS. WHEN SITE IS STABLE, PERFORM SITE PLANTINGS PER THE PLANTING PLAN, INCLUDING INSTALLATION OF HERBACEOUS MATERIAL PER THE PLANTING PLANS

2. PLANTING WORK SHALL OCCUR WITHIN THE EXTENTS OF THE PLANTING UNIT AREAS

ACCESS FOR ALL PLANTING WORK SHALL ALSO OCCUR BY BARGE.

4. PLANTING OF TIDAL MARSH AREAS SHALL OCCUR IN THE SPRING (AFTER APRIL 15 AND PRIOR TO JUNE 1) AND AFTER COMPLETION OF THE COBBLE BAR CONSTRUCTION

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APPROVED BY ME, AND THAT I AM A DULY LICENSED PROFESSIONAL

APPRO	)	REVISED
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BEST MANAGEMENT PRACTICES FOR WORKING IN NONTIDAL WETLANDS, WETLAND BUFFERS, WATERWAYS, AND 100-YEAR FLOODPLAINS

- 1. NO EXCESS FILL, CONSTRUCTION MATERIAL OR DEBRIS ARE TO BE STOCKPILED OR STORED IN NONTIDAL WETLANDS. NONTIDAL WETLAND BUFFERS, WATERWAYS, OR THE 100-YEAR FLOODPLAIN.
- 2. PLACE MATERIALS IN A LOCATION AND MANNER WHICH DOES NOT ADVERSELY IMPACT SURFACE OR SUBSURFACE WATER FLOW INTO OR OUT OF THE NONTIDAL WETLAND. NONTIDAL WETLAND BUFFERS. WATERWAYS. OR THE 100-YEAR FLOODPLAIN.
- 3. DO NOT USE THE EXCAVATED MATERIAL AS BACKFILL IF IT CONTAINS WASTE METAL PRODUCTS, UNSIGHTLY DEBRIS, TOXIC MATERIAL, OR ANY OTHER DELETERIOUS SUBSTANCE. IF ADDITIONAL BACKFILL IS REQUIRED, USE CLEAN MATERIAL FREE OF WASTE METAL PRODUCTS. UNSIGHTLY DEBRIS. TOXIC MATERIAL. OR ANY OTHER DELETERIOUS SUBSTANCE.
- 4. PLACE HEAVY EQUIPMENT ON MATS OR SUITABLY OPERATE THE EQUIPMENT TO PREVENT DAMAGE TO THE NONTIDAL WETLANDS. NONTIDAL WETLAND BUFFERS, WATERWAYS, OR THE 100-YEAR FLOODPLAIN.
- 5. REPAIR AND MAINTAIN ANY SERVICEABLE STRUCTURE OR FILL SO THERE IS NO PERMANENT LOSS OF NONTIDAL WETLAND, NONTIDAL WETLAND BUFFERS WATERWAYS, OR PERMANENT MODIFICATION OF THE 100-YEAR FLOODPLAIN IN EXCESS OF THAT LOST UNDER THE ORIGINALLY AUTHORIZED STRUCTURE OR FILL.
- RECTIFY ANY NONTIDAL WETLAND, NONTIDAL WETLAND BUFFERS, WATERWAYS, OR THE 100-YEAR FLOODPLAIN TEMPORARILY IMPACTED BY ANY CONSTRUCTION.
- 7. ALL TEMPORARY SEED STABILIZATION IN THE NONTIDAL WETLAND AND BUFFER SHALL CONSIST OF THE FOLLOWING SPECIES: ANNUAL RYEGRASS (lolium multiflorum), MILLET (setaria italica), BARLEY (hordeum sp.). OATS (uniola sp.) AND/OR RYE (secale cereale). THESE SPECIES WILL ALLOW FOR THE STABILIZATION OF THE SITE WHILE ALSO ALLOWING FOR THE VOLUNTARY **RE-VEGETATION OF NATURAL WETLANDS SPECIES. OTHER NON-PERSISTENT** VEGETATION MAY BE ACCEPTABLE, BUT MUST BE APPROVED BY THE NON-TIDAL WETLANDS AND WATERWAYS DIVISION. KENTUCKY 31 FESCUE SHALL NOT BE UTILIZED IN WETLAND OR BUFFER AREAS. THE AREA SHOULD BE SEEDED AND MULCHED TO REDUCE EROSION AFTER CONSTRUCTION ACTIVITIES HAVE BEEN COMPLETED.
- 8. AFTER INSTALLATION HAS BEEN COMPLETED, MAKE POST CONSTRUCTION GRADES AND ELEVATIONS OF NONTIDAL WETLANDS THE SAME AS THE ORIGINAL GRADES AND ELEVATIONS IN TEMPORARILY IMPACTED AREAS.
- 9. TO PROTECT IMPORTANT AQUATIC SPECIES, IN-STREAM WORK IS PROHIBITED AS DETERMINED BY THE CLASSIFICATION OF THE STREAM AS FOLLOWS: CLASS 1 MARCH 1 - JUNE 15. INCLUSIVE, DURING ANY YEAR.
- 10. STORMWATER RUNOFF FROM IMPERVIOUS SURFACES SHALL BE
- CONTROLLED TO PREVENT THE WASHING OF DEBRIS INTO THE WATERWAY. 11. CULVERT(S) SHALL BE CONSTRUCTED AND ANY RIP-RAP PLACED SO AS NOT TO OBSTRUCT THE MOVEMENT OF AQUATIC SPECIES, UNLESS THE PURPOSE OF THE ACTIVITY IS TO IMPROVE WATER.

## SEDIMENT CONTROL GENERAL NOTES

- 1. NOTIFY THE ANNE ARUNDEL COUNTY DEPARTMENT OF INSPECTION AND PERMITS 2 DAYS PRIOR TO STARTING WORK ON THIS PROJECT
- 2. ALL DISTURBED AREAS TO BE GRADED TO DRAIN TO A SEDIMENT DEVICE. NO DISTURBED AREAS TO BE ALLOWED TO DRAIN DIRECTLY OFF SITE.
- 3. THE CONTRACTOR SHALL BE RESPONSIBLE FOR ASSURING THAT THE SEDIMENT CONTROL MEASURES ARE FUNCTIONAL ON A DAY-TO-DAY BASIS
- 4. DISTURBED AREAS ALONG STORM DRAINS AND OUTFALLS SHALL BE STABILIZED IMMEDIATELY AFTER COMPLETION.
- 5. ALL SEDIMENT CONTROL FACILITIES ARE TO REMAIN IN PLACE UNTIL AREA ABOVE FACILITIES ARE STABILIZED AND PERMISSION FOR REMOVAL HAS BEEN OBTAINED FROM THE ANNE ARUNDEL COUNTY SEDIMENT CONTROL INSPECTOR.
- EXCESS EXCAVATION WILL BE HAULED TO A SITE APPROVED BY THE I & P INSPECTOR. THE CONTRACTOR SHALL BE RESPONSIBLE FOR OBTAINING APPROVAL BY THE A.A.CO. DEPT. OF INSPECTION AND PERMITS FOR ALL OFF-SITE BORROW PITS AND DISPOSAL AREAS.

2.4 AC (LIMITS OF DISTURBANCE)

0.4 AC ABOVE MHW

NOT APPLICABLE

NOT APPLICABLE

445 SF

NOT APPLICABLE

NOT APPLICABLE

NOT APPLICABLE


1000 CY

## SITE TABULATION


- 2. DISTURBED AREA
- 3. IN STREAM AREA NOT TO BE STABILIZED
- 4. AREA MECHANICALLY STABILIZED
- 5. AREA VEGETATIVELY STABILIZED
- 6. TOTAL CUT
- 7. TOTAL FILL
- 8. TOTAL SPOIL
- 9. TOTAL IMPORTED FILL

\* ESTIMATED INFORMATION NOT INTENDED FOR BIDDING

CAPE ST CLAIRE							
COMMUNITY IMPROVEMENT ASSOCIATION							
OVED	DATE	APPROVED	DATE	SCALE:	N/A	CAPE ST CLAIRE SHORELINE	
				DRAWN BY	TB,RW,AM,SE	ENHANCEMENT	
ENGINEER		PROJECT MANAGER		CHECKED BY	FAM, JC		
OVED	DATE	APPROVED	DATE	SHEET NO.	10 OF 18	SEQUENCE OF CONSTRUCTION	
				PROJECT NO.	19033.01	SC 01	
TANT CHIEF ENGINEER		CHIEF, RIGHT-OF-WAY		PROPOSAL NO.		SC-01	

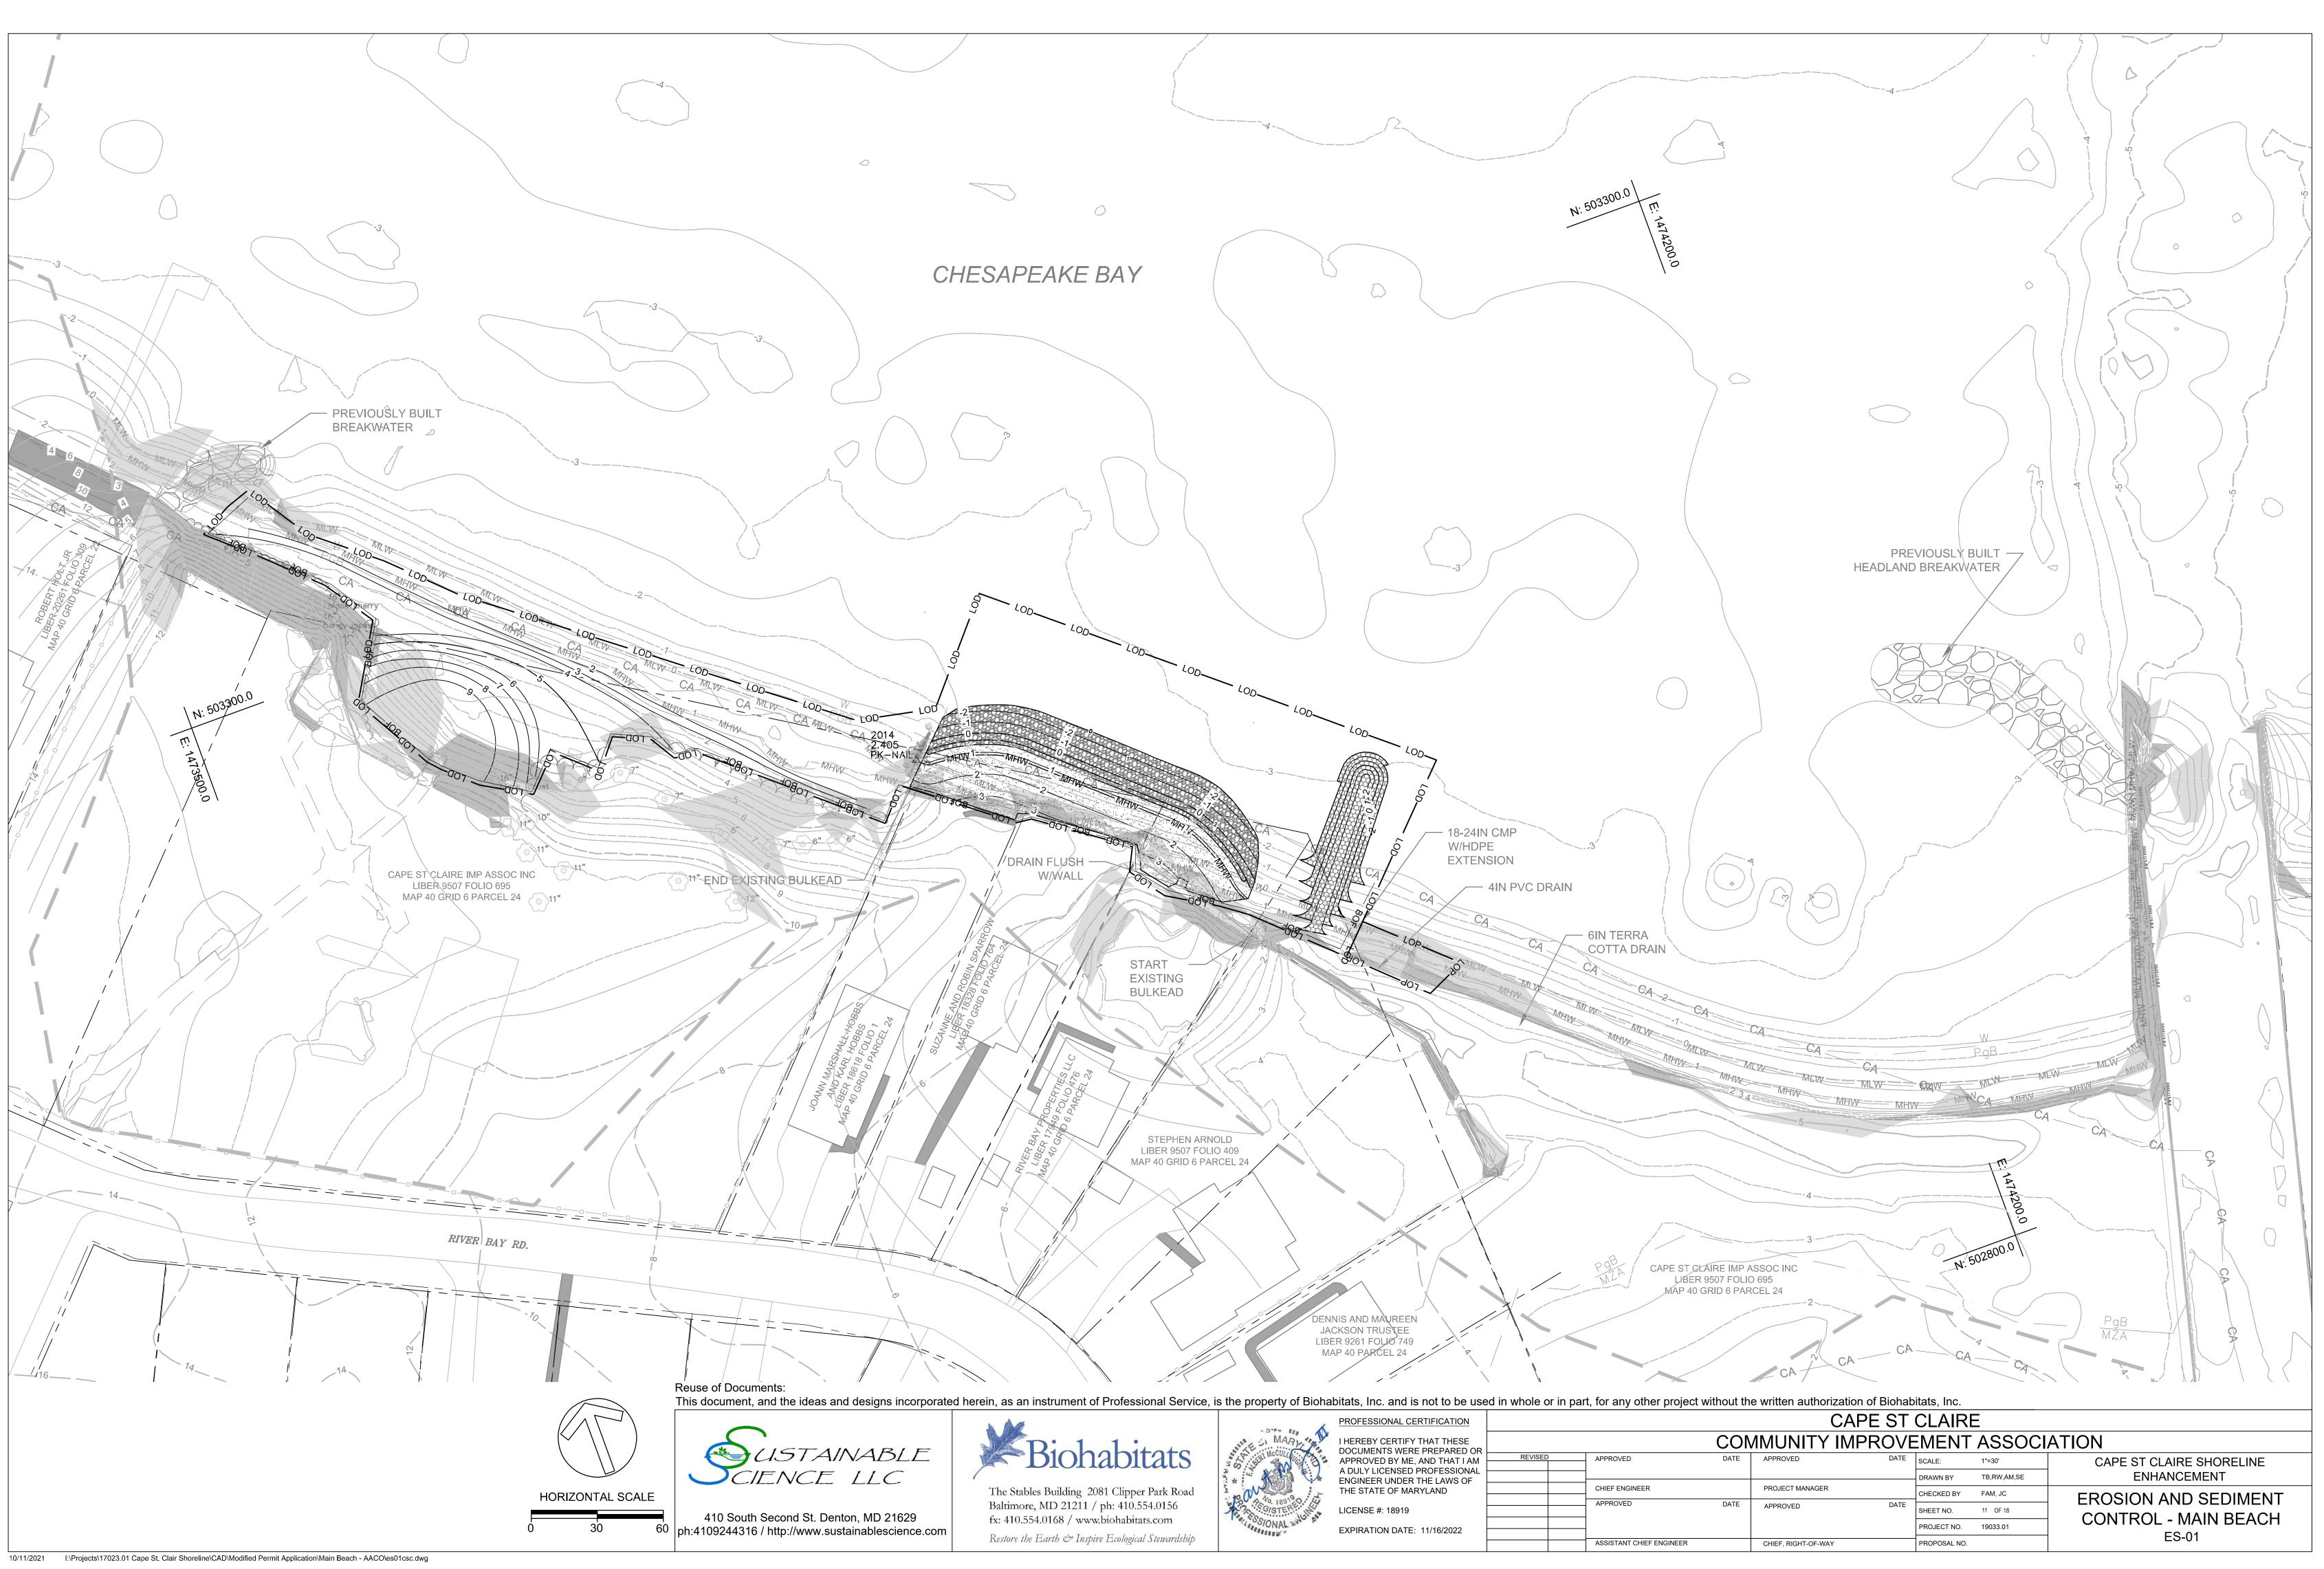

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DETAILS AND SPECIFICATIONS FOR VEGETATIVE ESTABLISHMENT

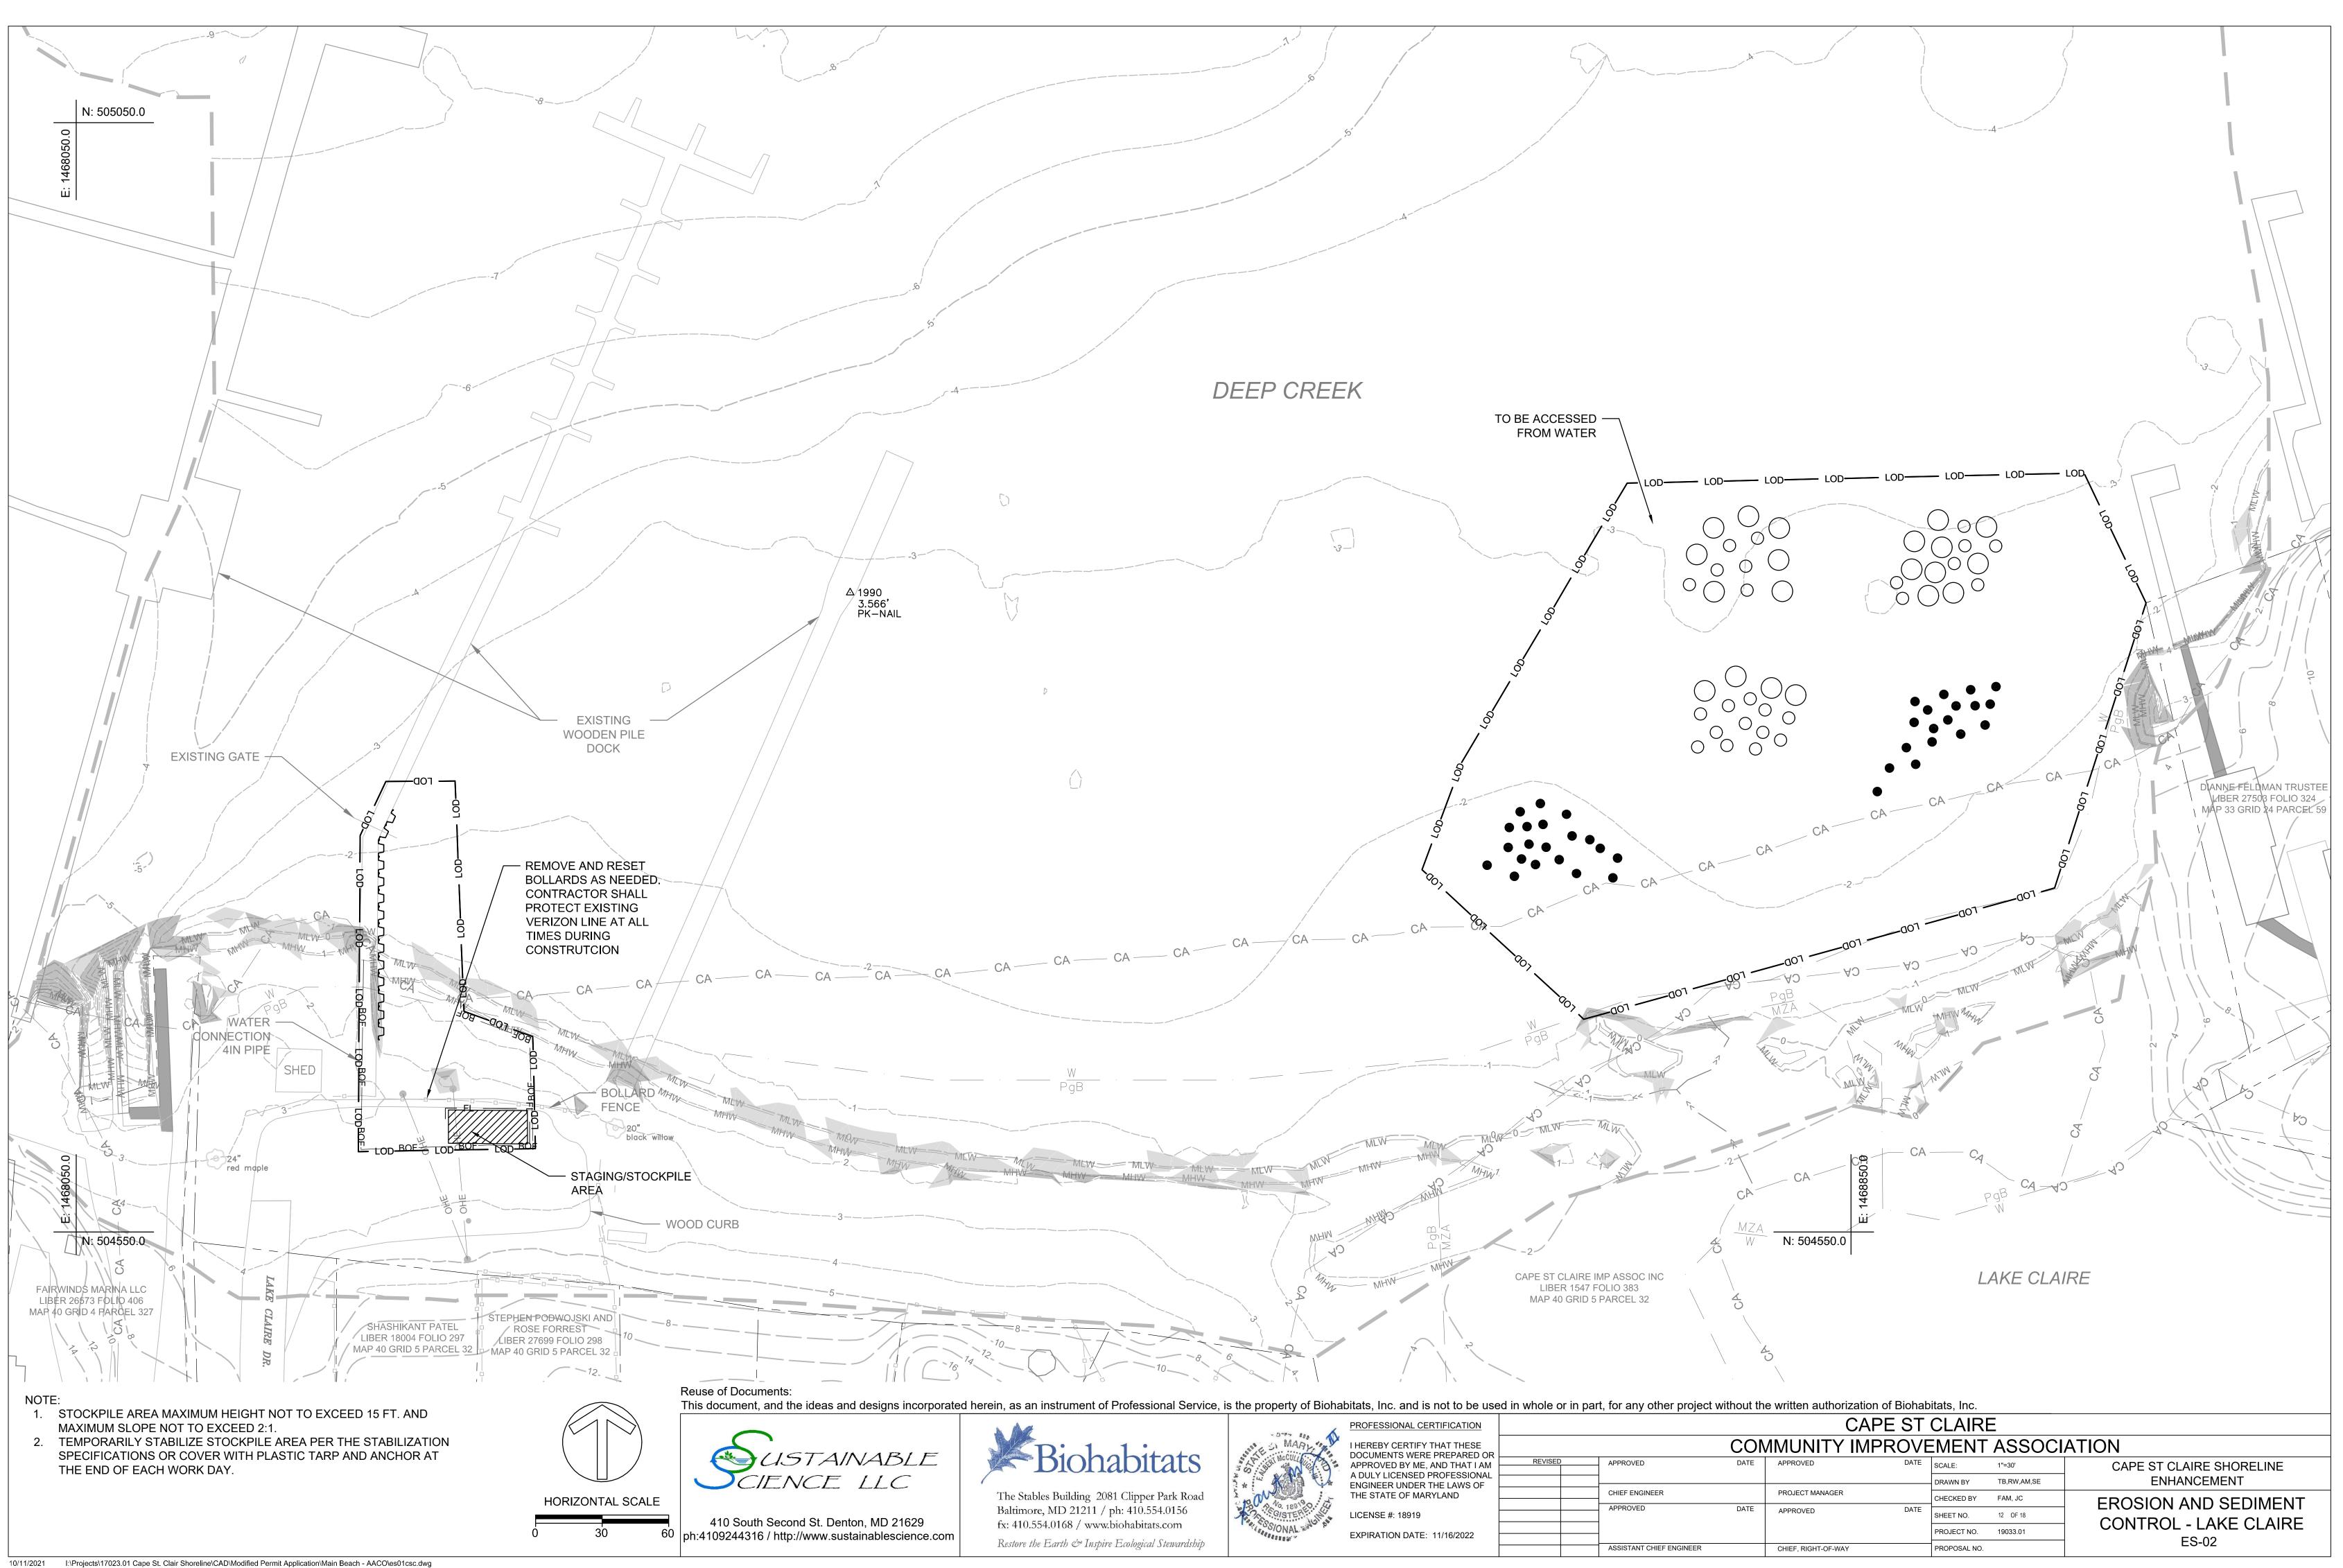FOLLOWING INITIAL SOIL DISTURBANCE OR REDISTURBANCE, PERMANENT OR TEMPORARY STABILIZATION SHALL BE COMPLETED WITHIN:

- I) THREE CALENDAR DAYS FOR THE SURFACE OF ALL PERIMETER CONTROLS, DIKES, SWALES, DITCHES, PERIMETER SLOPES AND ALL SLOPES GREATER THAN 3 HORIZONTAL TO 1 VERTICAL (3:1);
- II) SEVEN DAYS FOR ALL OTHER DISTURBED OR GRADED AREAS ON THE PROJECT SITE;
- III) THE ABOVE REQUIREMENTS DO NOT APPLY TO THOSE AREAS WHICH ARE SHOWN ON THE PLANS AND ARE CURRENTLY BEING USED FOR MATERIAL STORAGE OR FOR THOSE AREAS ON WHICH ACTUAL CONSTRUCTION ACTIVITIES ARE CURRENTLY BEING PERFORMED OR TO INTERIOR AREAS OF A SURFACE MINE SITE WHERE THE STABILIZATION OF MATERIAL WOULD CONTAMINATE THE RECOVERABLE RESOURCE. MAINTENANCE SHALL BE PERFORMED AS NECESSARY TO ENSURE THAT THE STABILIZED AREAS CONTINUOUSLY MEET THE APPROPRIATE REQUIREMENTS OF THE "1983 MARYLAND STANDARDS AND SPECIFICATIONS FOR SOIL EROSION AND SEDIMENT CONTROL."
- 1. PERMANENT SEEDING
- A. SOIL TESTS: LIME AND FERTILIZER WILL BE APPLIED PER SOIL TESTS RESULTS FOR SITES GREATER THAN 5 ACRES. SOIL TESTS WILL BE DONE AT COMPLETION OF INITIAL ROUGH GRADING OR AS RECOMMENDED BY THE SEDIMENT CONTROL INSPECTOR. RATES AND ANALYSES WILL BE PROVIDED TO THE GRADING INSPECTOR AS WELL AS THE CONTRACTOR.
- 1. OCCURRENCE OF ACID SULFATE SOILS (GRAYISH BLACK COLOR) WILL REQUIRE COVERING WITH A MINIMUM OF 12 INCHES OF CLEAN SOIL WITH 6 INCHES MINIMUM CAPPING OF TOP SOIL. NO STOCKPILING OF MATERIAL IS ALLOWED. IF NEEDED. SOIL TESTS SHOULD BE DONE BEFORE AND AFTER A 6-WEEK INCUBATION PERIOD TO ALLOW OXIDATION OF SULFATES.

THE MINIMUM SOIL CONDITIONS REQUIRED FOR PERMANENT VEGETATIVE ESTABLISHMENT ARE:

- A. SOIL PH SHALL BE BETWEEN 6.0 AND 7.0.
- B. SOLUBLE SALTS SHALL BE LESS THAN 500 PARTS PER MILLION (PPM)
- C. THE SOIL SHALL CONTAIN LESS THAN 40% CLAY BUT ENOUGH FINE GRAINED MATERIAL (> 30% SILT PLUS CLAY) TO PROVIDE THE CAPACITY TO HOLD A MODERATE AMOUNT OF MOISTURE. AN EXCEPTION IS IF LOVEGRASS OR SERECIA LESPEDEZA IS TO BE PLANTED, THEN A SANDY SOIL (< 30% SILT PLUS CLAY) WOULD BE ACCEPTABLE
- D. SOIL SHALL CONTAIN 1.5% MINIMUM ORGANIC MATTER BY WEIGHT. E. SOIL MUST CONTAIN SUFFICIENT PORE SPACE TO PERMIT ADEQUATE ROOT PENETRATION
- F. IF THESE CONDITIONS CANNOT BE MET BY SOILS ON SITE, ADDING TOPSOIL IS REQUIRED IN ACCORDANCE WITH SECTION 21 STANDARD AND SPECIFICATION FOR TOPSOIL OR AMENDMENTS MADE AS RECOMMENDED BY A CERTIFIED AGRONOMIST.
- B. SEEDBED PREPARATION: AREA TO BE SEEDED SHALL BE LOOSE AND FRIABLE TO A DEPTH OF AT LEAST 3 INCHES. THE TOP LAYER SHALL BE LOOSENED BY RAKING, DISKING OR OTHER ACCEPTABLE MEANS BEFORE SEEDING OCCURS. FOR SITES LESS THAN 5 ACRES APPLY 100 POUNDS DOLOMITIC LIMESTONE AND 21 POUNDS OF 10-10-10 FERTILIZER PER 1,000 SQUARE FEET. HARROW OR DISK LIME AND FERTILIZER INTO THE SOIL TO A DEPTH OF AT LEAST 3 INCHES ON SLOPES FLATTER THAN 3:1.
- C. SEEDING: APPLY 5-6 POUNDS PER 1,000 SQUARE FEET OF TALL FESCUE BETWEEN FEBRUARY 1 AND APRIL 30 OR BETWEEN AUGUST 15 AND OCTOBER 31. APPLY SEED UNIFORMLY ON A MOIST FIRM SEEDBED WITH A CYCLONE SEEDER, CULTIPACKER SEEDER OR HYDROSEEDER (SLURRY INCLUDES SEEDS AND FERTILIZER. RECOMMENDED ON STEEP SLOPES ONLY). MAXIMUM SEED DEPTH SHOULD BE 1/4 INCH IN CLAYEY SOILS AND 1/2 INCH IN SANDY SOILS WHEN USING OTHER THAN THE HYDROSEEDER METHOD. IRRIGATE WHERE NECESSARY TO SUPPORT ADEQUATE GROWTH UNTIL VEGETATION IS FIRMLY ESTABLISHED. IF OTHER SEED MIXES ARE TO BE USED. SELECT FROM TABLE 25. ENTITLED "PERMANENT SEEDING FOR LOW MAINTENANCE AREAS" FROM THE CURRENT STANDARDS AND SPECIFICATIONS FOR SOIL EROSION AND SEDIMENT CONTROL. MIXES SUITABLE FOR THIS ARE 1. 3 AND 5-7. MIXES 5-7 ARE SUITABLE IN NON-MOWABLE SITUATIONS.
- D. MULCHING: MULCH SHALL BE APPLIED TO ALL SEEDED AREAS IMMEDIATELY AFTER SEEDING. DURING THE TIME PERIODS WHEN SEEDING IS NOT PERMITTED. MULCH SHALL BE APPLIED IMMEDIATELY AFTER GRADING. MULCH SHALL BE UNROTTED. UNCHOPPED. SMALL GRAIN STRAW APPLIED AT A RATE OF 2 TONS PER ACRE OR 90 POUNDS PER 1,000 SQUARE FEET (2 BALES). IF A MULCH-ANCHORING TOOL IS USED, APPLY 2.5 TONS PER ACRE. MULCH MATERIALS SHALL BE RELATIVELY FREE OF ALL KINDS OF WEEDS AND SHALL BE COMPLETELY FREE OF PROHIBITED NOXIOUS WEEDS. SPREAD MULCH UNIFORMLY, MECHANICALLY OR BY HAND, TO A DEPTH OF 1-2 INCHES.
- E. SECURING STRAW MULCH: STRAW MULCH SHALL BE SECURED IMMEDIATELY FOLLOWING MULCH APPLICATION TO MINIMIZE MOVEMENT BY WIND OR WATER. THE FOLLOWING METHODS ARE PERMITTED:
  - 1. USE A MULCH-ANCHORING TOOL WHICH IS DESIGNED TO PUNCH AND ANCHOR MULCH INTO THE SOIL SURFACE TO A MINIMUM DEPTH OF 2 INCHES. THIS IS THE MOST EFFECTIVE METHOD FOR SECURING MULCH, HOWEVER, IT IS LIMITED TO RELATIVELY FLAT AREAS WHERE EQUIPMENT CAN OPERATE SAFELY.
  - 2. WOOD CELLULOSE FIBER MAY BE USED FOR ANCHORING STRAW. APPLY THE FIBER BINDER AT A NET DRY WEIGHT OF 750 POUNDS PER ACRE. IF MIXED WITH WATER, USE 50 POUNDS OF WOOD CELLULOSE FIBER PER 100 GALLONS OF WATER
  - 3. LIQUID BINDERS MAY BE USED. APPLY AT HIGHER RATES AT THE EDGES WHERE WIND CATCHES MULCH, SUCH AS IN VALLEYS AND ON CRESTS OF SLOPES. THE REMAINDER OF THE AREA SHOULD APPEAR UNIFORM AFTER BINDER APPLICATION. BINDERS LISTED IN THE 1994 STANDARDS AND SPECIFICATIONS FOR SOIL EROSION AND SEDIMENT CONTROL OR APPROVED EQUAL SHALL BE APPLIED AT RATES RECOMMENDED BY THE MANUFACTURERS.
  - 4. LIGHTWEIGHT PLASTIC NETTING MAY BE USED TO SECURE MULCH. THE NETTING WILL BE STAPLED TO THE GROUND ACCORDING TO MANUFACTURER'S RECOMMENDATIONS.

- 1. TEMPORARY SEEDING: MULCH: SAME AS 1 D AND E ABOVE.
- SLIPPAGE.
- PERFORMED TO ENSURE ESTABLISHMENT OF SOD.
- FEET.
- SOIL EROSION AND SEDIMENT CONTROL.
- FOR SOIL EROSION AND SEDIMENT CONTROL.

Reuse of Documents:



LIME: 100 POUNDS OF DOLOMITIC LIMESTONE PER 1,000 SQUARE FEET. FERTILIZER: 15 POUNDS OF 10-10-10 PER 1,000 SQUARE FEET. SEED: PERENNIAL RYE - 0.92 POUNDS PER 1.000 SQUARE FEET (FEBRUARY 1 THROUGH APRIL 30 OR AUGUST 15 THROUGH NOVEMBER 1). MILLET - 0.92 POUNDS PER 1,000 SQUARE FEET (MAY 1 THROUGH AUGUST 15).

2. NO FILLS MAY BE PLACED ON FROZEN GROUND. ALL FILL TO BE PLACED IN APPROXIMATELY HORIZONTAL LAYERS. EACH LAYER HAVING A LOOSE THICKNESS OF NOT MORE THAN 8 INCHES. ALL FILL IN ROADWAYS AND PARKING AREAS IS TO BE CLASSIFIED TYPE 2 AS PER ANNE ARUNDEL COUNTY CODE - ARTICLE 21, SECTION 2-308, AND COMPACTED TO 90% DENSITY; COMPACTION TO BE DETERMINED BY ASTM D-1557-66T (MODIFIED PROCTOR). ANY FILL WITHIN THE BUILDING AREA IS TO BE COMPACTED TO A MINIMUM OF 95% DENSITY AS DETERMINED BY METHODS PREVIOUSLY MENTIONED. FILLS FOR POND EMBANKMENTS SHALL BE COMPACTED AS PER MD-378 CONSTRUCTION SPECIFICATIONS. ALL OTHER FILLS SHALL BE COMPACTED SUFFICIENTLY SO AS TO BE STABLE AND PREVENT EROSION AND

3. PERMANENT SOD: INSTALLATION OF SOD SHOULD FOLLOW PERMANENT SEEDING DATES. SEEDBED PREPARATION FOR SOD SHALL BE AS NOTED IN SECTION (B) ABOVE. PERMANENT SOD IS TO BE TALL FESCUE. STATE APPROVED SOD: LIME AND FERTILIZER PER PERMANENT SEEDING SPECIFICATIONS AND LIGHTLY IRRIGATE SOIL PRIOR TO LAYING SOD. SOD IS TO BE LAID ON THE CONTOUR WITH ALL ENDS TIGHTLY ABUTTING, JOINTS ARE TO BE STAGGERED BETWEEN ROWS, WATER AND ROLL OR TAMP SOD TO INSURE POSITIVE ROOT CONTACT WITH THE SOIL. ALL SLOPES STEEPER THAN 3:1, AS SHOWN, ARE TO BE PERMANENTLY SODDED OR PROTECTED WITH AN APPROVED EROSION CONTROL NETTING. ADDITIONAL WATERING FOR ESTABLISHMENT MAY BE REQUIRED. SOD IS NOT TO BE INSTALLED ON FROZEN GROUND. SOD SHALL NOT BE TRANSPLANTED WHEN MOISTURE CONTENT (DRY OR WET) AND/OR EXTREME TEMPERATURE MAY ADVERSELY AFFECT ITS SURVIVAL. IN THE ABSENCE OF ADEQUATE RAINFALL, IRRIGATION SHOULD BE

4. MINING OPERATIONS: SEDIMENT CONTROL PLANS FOR MINING OPERATIONS MUST INCLUDE THE FOLLOWING SEEDING DATES AND MIXTURES: FOR SEEDING DATES OF: FEBRUARY 1 THROUGH APRIL 30 AND AUGUST 15 THROUGH OCTOBER 31, USE SEED MIXTURE OF TALL FESCUE AT THE RATE OF 2 POUNDS PER 1,000 SQUARE FEET AND SERICEA LESPEDEZA AT THE MINIMUM RATE OF 0.5 POUNDS PER 1,000 SQUARE

5. TOPSOIL SHALL BE APPLIED AS PER THE STANDARD AND SPECIFICATIONS FOR TOPSOIL FROM THE CURRENT MARYLAND STANDARDS AND SPECIFICATIONS FOR

NOTE: USE OF THIS INFORMATION DOES NOT PRECLUDE MEETING ALL OF THE REQUIREMENTS OF THE CURRENT MARYLAND STANDARDS AND SPECIFICATIONS B-4-2 STANDARDS AND SPECIFICATIONS FOR SOIL PREPARATION, TOPSOILING, AND SOIL AMENDMENTS

DEFINITION - THE PROCESS OF PREPARING THE SOILS TO SUSTAIN ADEQUATE VEGETATIVE STABILIZATION.

PURPOSE - TO PROVIDE A SUITABLE SOIL MEDIUM FOR VEGETATIVE GROWTH

CONDITIONS WHERE PRACTICE APPLIES - WHERE VEGETATIVE STABILIZATION IS TO BE ESTABLISHED.

## **CRITERIA**

- A. SOIL PREPARATION TEMPORARY STABILIZATION 1.
  - A. SEEDBED PREPARATION CONSISTS OF LOOSENING SOIL TO A DEPTH OF 3 TO 5 INCHES BY MEANS OF SUITABLE AGRICULTURAL OR CONSTRUCTION EQUIPMENT, SUCH AS DISC HARROWS OR CHISEL PLOWS OR RIPPERS MOUNTED ON CONSTRUCTION EQUIPMENT. AFTER THE SOIL IS LOOSENED, IT MUST NOT BE ROLLED OR DRAGGED SMOOTH BUT LEFT IN THE ROUGHENED CONDITION. SLOPES 3:1 OR FLATTER ARE TO BE TRACKED WITH RIDGES RUNNING PARALLEL TO THE CONTOUR OF THE SLOPE.
  - B. APPLY FERTILIZER AND LIME AS PRESCRIBED ON THE PLANS. C. INCORPORATE LIME AND FERTILIZER INTO THE TOP 3 TO 5 INCHES OF SOIL BY DISKING OR OTHER SUITABLE MEANS.
  - 2. PERMANENT STABILIZATION
  - A. A SOIL TEST IS REQUIRED FOR ANY EARTH DISTURBANCE OF 5 ACRES OR MORE THE MINIMUM SOIL CONDITIONS REQUIRED FOR PERMANENT VEGETATIVE ESTABLISHMENT ARE:
    - I. SOIL PH BETWEEN 6.0 AND 7.0.
    - II. SOLUBLE SALTS LESS THAN 500 PARTS PER MILLION (PPM) **III. SOIL CONTAINS LESS THAN 40 PERCENT CLAY BUT ENOUGH FINE GRAINED** MATERIAL (GREATER THAN 30 PERCENT SILT PLUS CLAY) TO PROVIDE THE CAPACITY TO HOLD A MODERATE AMOUNT OF MOISTURE. AN EXCEPTION: IF LOVEGRASS WILL BE PLANTED, THEN A SANDY SOIL (LESS THAN 30 PERCENT
    - SILT PLUS CLAY) WOULD BE ACCEPTABLE. IV. SOIL CONTAINS 1.5 PERCENT MINIMUM ORGANIC MATTER BY WEIGHT. V. SOIL CONTAINS SUFFICIENT PORE SPACE TO PERMIT ADEQUATE ROOT

PENETRATION.

B. APPLICATION OF AMENDMENTS OR TOPSOIL IS REQUIRED IF ON-SITE SOILS DO NOT MEET THE ABOVE CONDITIONS.

- C. GRADED AREAS MUST BE MAINTAINED IN A TRUE AND EVEN GRADE AS SPECIFIED ON THE APPROVED PLAN, THEN SCARIFIED OR OTHERWISE LOOSENED TO A DEPTH OF 3 TO 5 INCHES.
- D. APPLY SOIL AMENDMENTS AS SPECIFIED ON THE APPROVED PLAN OR AS INDICATED BY THE RESULTS OF A SOIL TEST.
- E. MIX SOIL AMENDMENTS INTO THE TOP 3 TO 5 INCHES OF SOIL BY DISKING OR OTHER SUITABLE MEANS. RAKE LAWN AREAS TO SMOOTH THE SURFACE, REMOVE LARGE OBJECTS LIKE STONES AND BRANCHES. AND READY THE AREA FOR SEED APPLICATION. LOOSEN SURFACE SOIL BY DRAGGING WITH A HEAVY CHAIN OR OTHER EQUIPMENT TO ROUGHEN THE SURFACE WHERE SITE CONDITIONS WILL NOT PERMIT NORMAL SEEDBED PREPARATION. TRACK SLOPES 3:1 OR FLATTER WITH TRACKED EQUIPMENT LEAVING THE SOIL IN AN IRREGULAR CONDITION WITH RIDGES RUNNING PARALLEL TO THE CONTOUR OF THE SLOPE. LEAVE THE TOP 1 TO 3 INCHES OF SOIL LOOSE AND FRIABLE. SEEDBED LOOSENING MAY BE UNNECESSARY ON NEWLY DISTURBED AREAS.
- B. TOPSOILING
  - 1. TOPSOIL IS PLACED OVER PREPARED SUBSOIL PRIOR TO ESTABLISHMENT OF PERMANENT VEGETATION. THE PURPOSE IS TO PROVIDE A SUITABLE SOIL MEDIUM FOR VEGETATIVE GROWTH. SOILS OF CONCERN HAVE LOW MOISTURE CONTENT. LOW NUTRIENT LEVELS, LOW PH, MATERIALS TOXIC TO PLANTS, AND/OR UNACCEPTABLE SOIL GRADATION.
  - 2. TOPSOIL SALVAGED FROM AN EXISTING SITE MAY BE USED PROVIDED IT MEETS THE STANDARDS AS SET FORTH IN THESE SPECIFICATIONS. TYPICALLY. THE DEPTH OF TOPSOIL TO BE SALVAGED FOR A GIVEN SOIL TYPE CAN BE FOUND IN THE REPRESENTATIVE SOIL PROFILE SECTION IN THE SOIL SURVEY PUBLISHED BY USDA-NRCS.
  - 3. TOPSOILING IS LIMITED TO AREAS HAVING 2:1 OR FLATTER SLOPES WHERE:
  - A. THE TEXTURE OF THE EXPOSED SUBSOIL/PARENT MATERIAL IS NOT ADEQUATE TO PRODUCE VEGETATIVE GROWTH.
  - B. THE SOIL MATERIAL IS SO SHALLOW THAT THE ROOTING ZONE IS NOT DEEP ENOUGH TO SUPPORT PLANTS OR FURNISH CONTINUING SUPPLIES OF MOISTURE AND PLANT NUTRIENTS.
  - C. THE ORIGINAL SOIL TO BE VEGETATED CONTAINS MATERIAL TOXIC TO PLANT GROWTH.
  - D. THE SOIL IS SO ACIDIC THAT TREATMENT WITH LIMESTONE IS NOT FEASIBLE.
  - 4. AREAS HAVING SLOPES STEEPER THAN 2:1 REQUIRE SPECIAL CONSIDERATION AND DESIGN.
  - 5. TOPSOIL SPECIFICATIONS: SOIL TO BE USED AS TOPSOIL MUST MEET THE FOLLOWING CRITERIA:
    - A. TOPSOIL MUST BE A LOAM, SANDY LOAM, CLAY LOAM, SILT LOAM, SANDY CLAY LOAM, OR LOAMY SAND. OTHER SOILS MAY BE USED IF RECOMMENDED BY AN

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PROFESSIONAL CERTIFICATION

CAPE ST CLAIRE								
COMMUNITY IMPROVEMENT ASSOCIATION								
APPROVED DATE	APPROVED DA	ATE	SCALE:	NTS	CAPE ST CLAIRE SHORELINE			
			DRAWN BY	TB,RW,AM,SE	ENHANCEMENT			
CHIEF ENGINEER	PROJECT MANAGER		CHECKED BY	FAM, JC	EROSION AND SEDIMENT			
APPROVED DATE	APPROVED DA	ATE	SHEET NO.	13 OF 18	CONTROL NOTES			
			PROJECT NO.	19033.01				
ASSISTANT CHIEF ENGINEER	CHIEF, RIGHT-OF-WAY		PROPOSAL NO.		ES-03			

CADE ST CLAIDE

AGRONOMIST OR SOIL SCIENTIST AND APPROVED BY THE APPROPRIATE APPROVAL AUTHORITY. TOPSOIL MUST NOT BE A MIXTURE OF CONTRASTING TEXTURED SUBSOILS AND MUST CONTAIN LESS THAN 5 PERCENT BY VOLUME OF CINDERS, STONES, SLAG, COARSE FRAGMENTS, GRAVEL, STICKS, ROOTS, TRASH. OR OTHER MATERIALS LARGER THAN 1½ INCHES IN DIAMETER.

- B. TOPSOIL MUST BE FREE OF NOXIOUS PLANTS OR PLANT PARTS SUCH AS BERMUDA GRASS, QUACK GRASS, JOHNSON GRASS, NUT SEDGE, POISON IVY, THISTLE, OR OTHERS AS SPECIFIED.
- C. TOPSOIL SUBSTITUTES OR AMENDMENTS, AS RECOMMENDED BY A QUALIFIED AGRONOMIST OR SOIL SCIENTIST AND APPROVED BY THE APPROPRIATE APPROVAL AUTHORITY, MAY BE USED IN LIEU OF NATURAL TOPSOIL.

6. TOPSOIL APPLICATION

- A. EROSION AND SEDIMENT CONTROL PRACTICES MUST BE MAINTAINED WHEN APPLYING TOPSOIL
- B. UNIFORMLY DISTRIBUTE TOPSOIL IN A 5 TO 8 INCH LAYER AND LIGHTLY COMPACT TO A MINIMUM THICKNESS OF 4 INCHES. SPREADING IS TO BE PERFORMED IN SUCH A MANNER THAT SODDING OR SEEDING CAN PROCEED WITH A MINIMUM OF ADDITIONAL SOIL PREPARATION AND TILLAGE. ANY IRREGULARITIES IN THE SURFACE RESULTING FROM TOPSOILING OR OTHER OPERATIONS MUST BE CORRECTED IN ORDER TO PREVENT THE FORMATION OF DEPRESSIONS OR WATER POCKETS.
- C. TOPSOIL MUST NOT BE PLACED IF THE TOPSOIL OR SUBSOIL IS IN A FROZEN OR MUDDY CONDITION, WHEN THE SUBSOIL IS EXCESSIVELY WET OR IN A CONDITION THAT MAY OTHERWISE BE DETRIMENTAL TO PROPER GRADING AND SEEDBED PREPARATION.
- C. SOIL AMENDMENTS (FERTILIZER AND LIME SPECIFICATIONS)
  - 1. SOIL TESTS MUST BE PERFORMED TO DETERMINE THE EXACT RATIOS AND APPLICATION RATES FOR BOTH LIME AND FERTILIZER ON SITES HAVING DISTURBED AREAS OF 5 ACRES OR MORE. SOIL ANALYSIS MAY BE PERFORMED BY A RECOGNIZED PRIVATE OR COMMERCIAL LABORATORY. SOIL SAMPLES TAKEN FOR ENGINEERING PURPOSES MAY ALSO BE USED FOR CHEMICAL ANALYSES
  - 2. FERTILIZERS MUST BE UNIFORM IN COMPOSITION, FREE FLOWING AND SUITABLE FOR ACCURATE APPLICATION BY APPROPRIATE EQUIPMENT. MANURE MAY BE SUBSTITUTED FOR FERTILIZER WITH PRIOR APPROVAL FROM THE APPROPRIATE APPROVAL AUTHORITY. FERTILIZERS MUST ALL BE DELIVERED TO THE SITE FULLY LABELED ACCORDING TO THE APPLICABLE LAWS AND MUST BEAR THE NAME, TRADE NAME OR TRADEMARK AND WARRANTY OF THE PRODUCER.
  - 3. LIME MATERIALS MUST BE GROUND LIMESTONE (HYDRATED OR BURNT LIME MAY BE SUBSTITUTED EXCEPT WHEN HYDROSEEDING) WHICH CONTAINS AT LEAST 50 PERCENT TOTAL OXIDES (CALCIUM OXIDE PLUS MAGNESIUM OXIDE). LIMESTONE MUST BE GROUND TO SUCH FINENESS THAT AT LEAST 50 PERCENT WILL PASS THROUGH A #100 MESH SIEVE AND 98 TO 100 PERCENT WILL PASS THROUGH A #20 MESH SIEVE.
  - 4. LIME AND FERTILIZER ARE TO BE EVENLY DISTRIBUTED AND INCORPORATED INTO THE TOP 3 TO 5 INCHES OF SOIL BY DISKING OR OTHER SUITABLE MEANS.
  - 5. WHERE THE SUBSOIL IS EITHER HIGHLY ACIDIC OR COMPOSED OF HEAVY CLAYS. SPREAD GROUND LIMESTONE AT THE RATE OF 4 TO 8 TONS/ACRE (200-400 POUNDS PER 1,000 SQUARE FEET) PRIOR TO THE PLACEMENT OF TOPSOIL.

#### **B-4-5 STANDARDS AND SPECIFICATIONS**

FOR

#### PERMANENT STABILIZATION

#### <u>Definition</u>

To stabilize disturbed soils with permanent vegetation.

#### Purpose

To use long-lived perennial grasses and legumes to establish permanent ground cover on disturbed soils.

#### Conditions Where Practice Applies

Exposed soils where ground cover is needed for 6 months or more.

### Criteria

#### A. Seed Mixtures

- 1. General Use
- a. Select one or more of the species or mixtures listed in Table B.3 for the appropriate Plant Hardiness Zone (from Figure B.3) and based on the site condition or purpose found on Table B.2. Enter selected mixture(s), application rates, and seeding dates in the Permanent Seeding Summary. The Summary is to be placed on the plan.
- b. Additional planting specifications for exceptional sites such as shorelines, stream banks, or dunes or for special purposes such as wildlife or aesthetic treatment may be found in USDA-NRCS Technical Field Office Guide, Section 342 - Critical Area Planting.
- c. For sites having disturbed area over 5 acres, use and show the rates recommended by the soil testing agency.
- d. For areas receiving low maintenance, apply urea form fertilizer (46-0-0) at 3 1/2 pounds per 1000 square feet (150 pounds per acre) at the time of seeding in addition to the soil amendments shown in the Permanent Seeding Summary .

#### 2. Turfgrass Mixtures

- a. Areas where turfgrass may be desired include lawns, parks, playgrounds, and commercial sites which will receive a medium to high level of maintenance.
- b. Select one or more of the species or mixtures listed below based on the site conditions or purpose. Enter selected mixture(s), application rates, and seeding dates in the Permanent Seeding Summary. The summary is to be placed on the plan.
- i. Kentucky Bluegrass: Full Sun Mixture: For use in areas that receive intensive management. Irrigation required in the areas of central Maryland and Eastern Shore. Recommended Certified Kentucky Bluegrass Cultivars Seeding Rate: 1.5 to 2.0 pounds per 1000 square feet. Choose a minimum of three Kentucky bluegrass cultivars with each ranging from 10 to 35 percent of the total mixture by weight.
- ii. Kentucky Bluegrass/Perennial Rye: Full Sun Mixture: For use in full sun areas where

#### B.21

#### **B-4-4 STANDARDS AND SPECIFICATIONS**

#### **FOR**

#### **TEMPORARY STABILIZATION**

Definition

To stabilize disturbed soils with vegetation for up to 6 months.

#### Purpose

To use fast growing vegetation that provides cover on disturbed soils.

#### Conditions Where Practice Applies

Exposed soils where ground cover is needed for a period of 6 months or less. For longer duration of time, permanent stabilization practices are required.

#### <u>Criteria</u>

- 1. Select one or more of the species or seed mixtures listed in Table B.1 for the appropriate Plant Hardiness Zone (from Figure B.3), and enter them in the Temporary Seeding Summary below along with application rates, seeding dates and seeding depths. If this Summary is not put on the plan and completed, then Table B.1 plus fertilizer and lime rates must be put on the plan.
- 2. For sites having soil tests performed, use and show the recommended rates by the testing agency. Soil tests are not required for Temporary Seeding.
- 3. When stabilization is required outside of a seeding season, apply seed and mulch or straw mulch alone as prescribed in Section B-4-3.A.1.b and maintain until the next seeding season.

#### **Temporary Seeding Summary**

	Hardiness Z Seed Mixtur	Fertilizer Rate	Lime Rate			
No.	Species	Application Rate (lb/ac)	Seeding Dates	Seeding Depths	(10-20-20)	
_					436 lb/ac	2 tons/ac
					(10 lb/1000 sf)	(90 lb/1000 sf)

B.18

rapid establishment is necessary and when turf will receive medium to intensive management. Certified Perennial Ryegrass Cultivars/Certified Kentucky Bluegrass Seeding Rate: 2 pounds mixture per 1000 square feet. Choose a minimum of three Kentucky bluegrass cultivars with each ranging from 10 to 35 percent of the total mixture by weight.

- Notes:

Choose certified material. Certified material is the best guarantee of cultivar purity. The certification program of the Maryland Department of Agriculture, Turf and Seed Section, provides a reliable means of consumer protection and assures a pure genetic line

c. Ideal Times of Seeding for Turf Grass Mixtures Western MD: March 15 to June 1, August 1 to October 1 (Hardiness Zones: 5b, 6a)

Central MD: March 1 to May 15, August 15 to October 15 (Hardiness Zone: 6b)

Southern MD, Eastern Shore: March 1 to May 15, August 15 to October 15 (Hardiness Zones: 7a, 7b)

- pose no difficulty.
- seasons, or on adverse sites.

**B-4-8 STANDARDS AND SPECIFICATIONS** 

A mound or pile of soil protected by appropriately designed erosion and sediment control measures.

To provide a designated location for the temporary storage of soil that controls the potential for erosion, sedimentation, and changes to drainage patterns.

Stockpile areas are utilized when it is necessary to salvage and store soil for later use.

- erosion and sediment control plan.
- with Section B-3 Land Grading.
- 4. Access the stockpile area from the upgrade side.
- concentrated flow in a non-erosive manner.
- control practice must be used to intercept the discharge.
- sheeting.

The stockpile area must continuously meet the requirements for Adequate Vegetative Establishment in accordance with Section B-4 Vegetative Stabilization. Side slopes must be maintained at no steeper than a 2:1 ratio. The stockpile area must be kept free of erosion. If the vertical height of a stockpile exceeds 20 feet for 2:1 slopes, 30 feet for 3:1 slopes, or 40 feet for 4:1 slopes, benching must be provided in accordance with Section B-3 Land Grading.

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iii. Tall Fescue/Kentucky Bluegrass: Full Sun Mixture: For use in drought prone areas and/or for areas receiving low to medium management in full sun to medium shade. Recommended mixture includes; Certified Tall Fescue Cultivars 95 to 100 percent, Certified Kentucky Bluegrass Cultivars 0 to 5 percent. Seeding Rate: 5 to 8 pounds per 1000 square feet. One or more cultivars may be blended.

iv. Kentucky Bluegrass/Fine Fescue: Shade Mixture: For use in areas with shade in Bluegrass lawns. For establishment in high quality, intensively managed turf area. Mixture includes; Certified Kentucky Bluegrass Cultivars 30 to 40 percent and Certified Fine Fescue and 60 to 70 percent. Seeding Rate: 1½ to 3 pounds per 1000 square feet.

#### Select turfgrass varieties from those listed in the most current University of Maryland Publication, Agronomy Memo #77, "Turfgrass Cultivar Recommendations for Maryland"

d. Till areas to receive seed by disking or other approved methods to a depth of 2 to 4 inches, level and rake the areas to prepare a proper seedbed. Remove stones and debris over 11/2 inches in diameter. The resulting seedbed must be in such condition that future mowing of grasses will

e. If soil moisture is deficient, supply new seedings with adequate water for plant growth ( $\frac{1}{2}$  to 1 inch every 3 to 4 days depending on soil texture) until they are firmly established. This is especially true when seedings are made late in the planting season, in abnormally dry or hot

B.22

## FOR

**STOCKPILE AREA** 

#### Definition

#### Purpose

Conditions Where Practice Applies

#### Criteria

1. The stockpile location and all related sediment control practices must be clearly indicated on the

2. The footprint of the stockpile must be sized to accommodate the anticipated volume of material and based on a side slope ratio no steeper than 2:1. Benching must be provided in accordance

3. Runoff from the stockpile area must drain to a suitable sediment control practice.

5. Clear water runoff into the stockpile area must be minimized by use of a diversion device such as an earth dike, temporary swale or diversion fence. Provisions must be made for discharging

6. Where runoff concentrates along the toe of the stockpile fill, an appropriate erosion/sediment

7. Stockpiles must be stabilized in accordance with the 3/7 day stabilization requirement as well as Standard B-4-1 Incremental Stabilization and Standard B-4-4 Temporary Stabilization.

8. If the stockpile is located on an impervious surface, a liner should be provided below the stockpile to facilitate cleanup. Stockpiles containing contaminated material must be covered with impermeable

#### Maintenance

B.43

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A DULY LICENSED PROFESSIONAL

APPR CHIEF APPR

#### **Permanent Seeding Summary**

		<b>Zone</b> (from Figure re (from Table B.		]	- Lime Rate				
No.	Species	Application Rate (lb/ac)	Seeding Dates	Seeding Depths	Ν	P <sub>2</sub> O <sub>5</sub>	K <sub>2</sub> 0	Linie Rute	
				1⁄4- 1⁄2 in	per acre (1.0 lb/	90 lb/ac	90 lb/ac	2 tons/ac	
				1⁄4- 1⁄2 in		(2 lb/	(2 lb/	(90 lb/ 1000 sf)	
				1⁄4- 1⁄2 in		1000 sf)	1000 sf)		

B. Sod: To provide quick cover on disturbed areas (2:1 grade or flatter).

1. General Specifications

- a. Class of turfgrass sod must be Maryland State Certified. Sod labels must be made available to the job foreman and inspector.
- b. Sod must be machine cut at a uniform soil thickness of <sup>3</sup>/<sub>4</sub> inch, plus or minus <sup>1</sup>/<sub>4</sub> inch, at the time of cutting. Measurement for thickness must exclude top growth and thatch. Broken pads and torn or uneven ends will not be acceptable.
- c. Standard size sections of sod must be strong enough to support their own weight and retain their size and shape when suspended vertically with a firm grasp on the upper 10 percent of the section.
- d. Sod must not be harvested or transplanted when moisture content (excessively dry or wet) may adversely affect its survival.
- e. Sod must be harvested, delivered, and installed within a period of 36 hours. Sod not transplanted within this period must be approved by an agronomist or soil scientist prior to its installation.

2. Sod Installation

- a. During periods of excessively high temperature or in areas having dry subsoil, lightly irrigate the subsoil immediately prior to laying the sod.
- b. Lay the first row of sod in a straight line with subsequent rows placed parallel to it and tightly wedged against each other. Stagger lateral joints to promote more uniform growth and strength. Ensure that sod is not stretched or overlapped and that all joints are butted tight in order to prevent voids which would cause air drying of the roots.
- c. Wherever possible, lay sod with the long edges parallel to the contour and with staggering joints. Roll and tamp, peg or otherwise secure the sod to prevent slippage on slopes. Ensure solid contact exists between sod roots and the underlying soil surface.
- d. Water the sod immediately following rolling and tamping until the underside of the new sod pad and soil surface below the sod are thoroughly wet. Complete the operations of laying, tamping and irrigating for any piece of sod within eight hours.

B.23


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#### 3. Sod Maintenance


- a. In the absence of adequate rainfall, water daily during the first week or as often and sufficiently as necessary to maintain moist soil to a depth of 4 inches. Water sod during the heat of the day to prevent wilting.
- b. After the first week, sod watering is required as necessary to maintain adequate moisture content.
- c. Do not mow until the sod is firmly rooted. No more than  $\frac{1}{3}$  of the grass leaf must be removed by the initial cutting or subsequent cuttings. Maintain a grass height of at least 3 inches unless otherwise specified.

B.24

CAPE ST CLAIRE								
COMMUNITY IMPROVEMENT ASSOCIATION								
ROVED	DATE	APPROVED	DATE	SCALE:	NTS	CAPE ST CLAIRE SHORELINE		
				DRAWN BY	TB,RW,AM,SE	ENHANCEMENT		
FENGINEER		PROJECT MANAGER		CHECKED BY	FAM, JC	EROSION AND SEDIMENT		
ROVED	DATE	APPROVED	DATE	SHEET NO.	14 OF 18	CONTROL NOTES		
				PROJECT NO.	19033.01			
STANT CHIEF ENGINEER		CHIEF, RIGHT-OF-WAY		PROPOSAL NO.		ES-04		

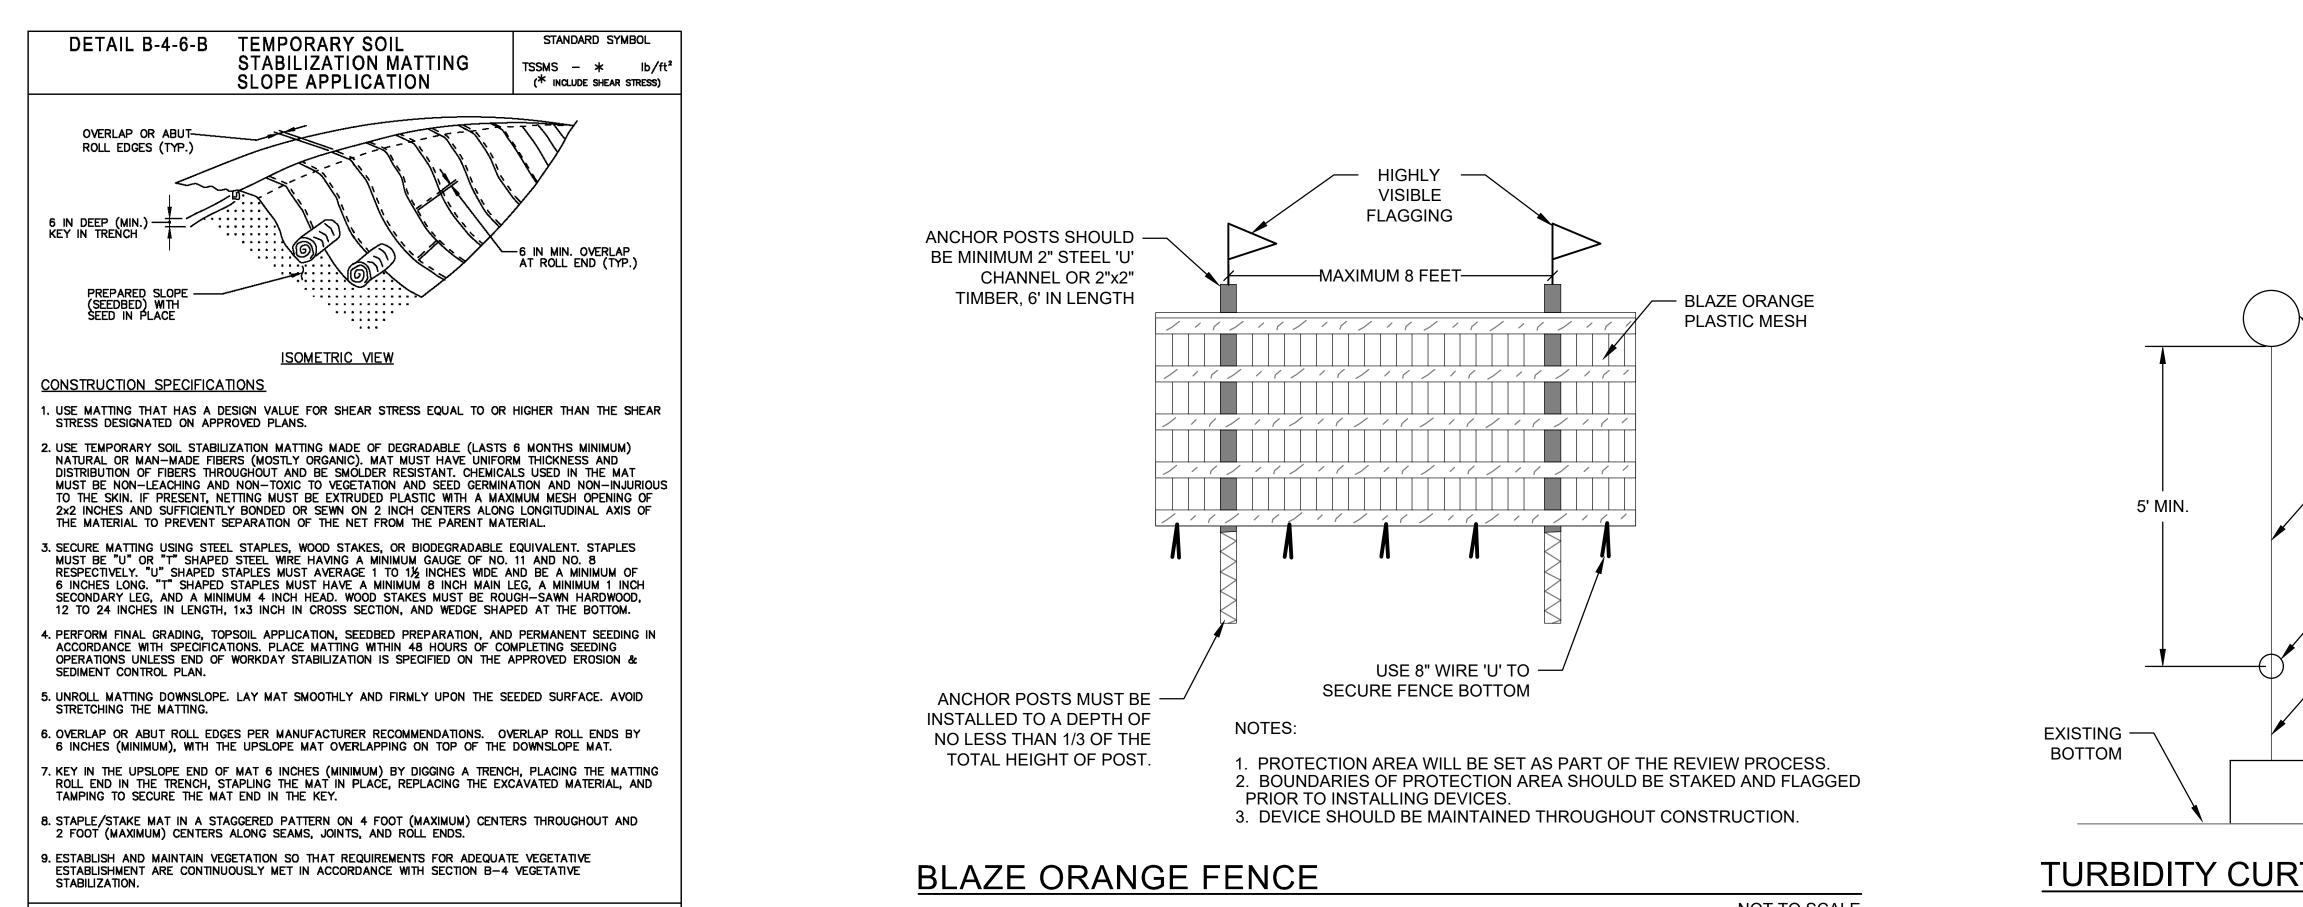

MARYLAND STANDARDS AND SPECIFICATIONS FOR SOIL EROSION AND SEDIMENT CONTROL MARYLAND DEPARTMENT OF ENVIRONMENT U.S. DEPARTMENT OF AGRICULTURE 2011 NATURAL RESOURCES CONSERVATION SERVICE WATER MANAGEMENT ADMINISTRATION

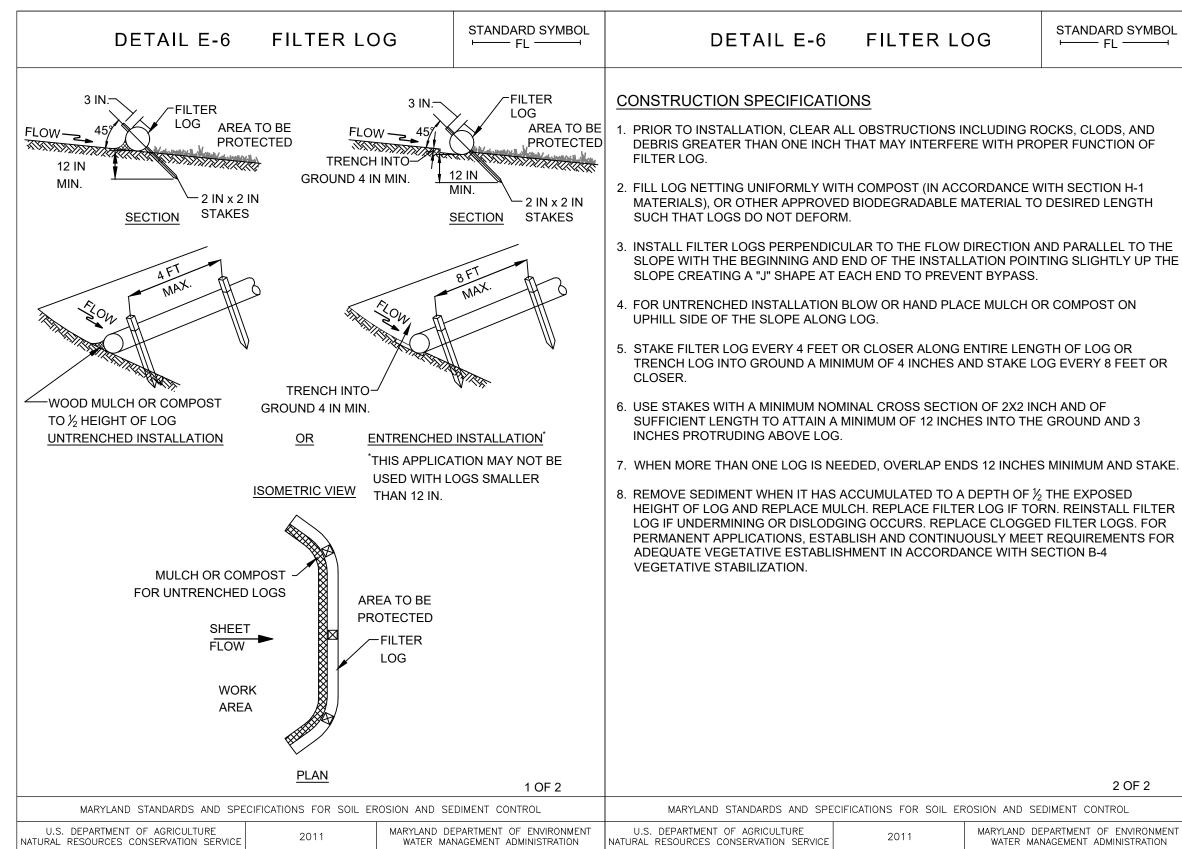

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2 OF 2

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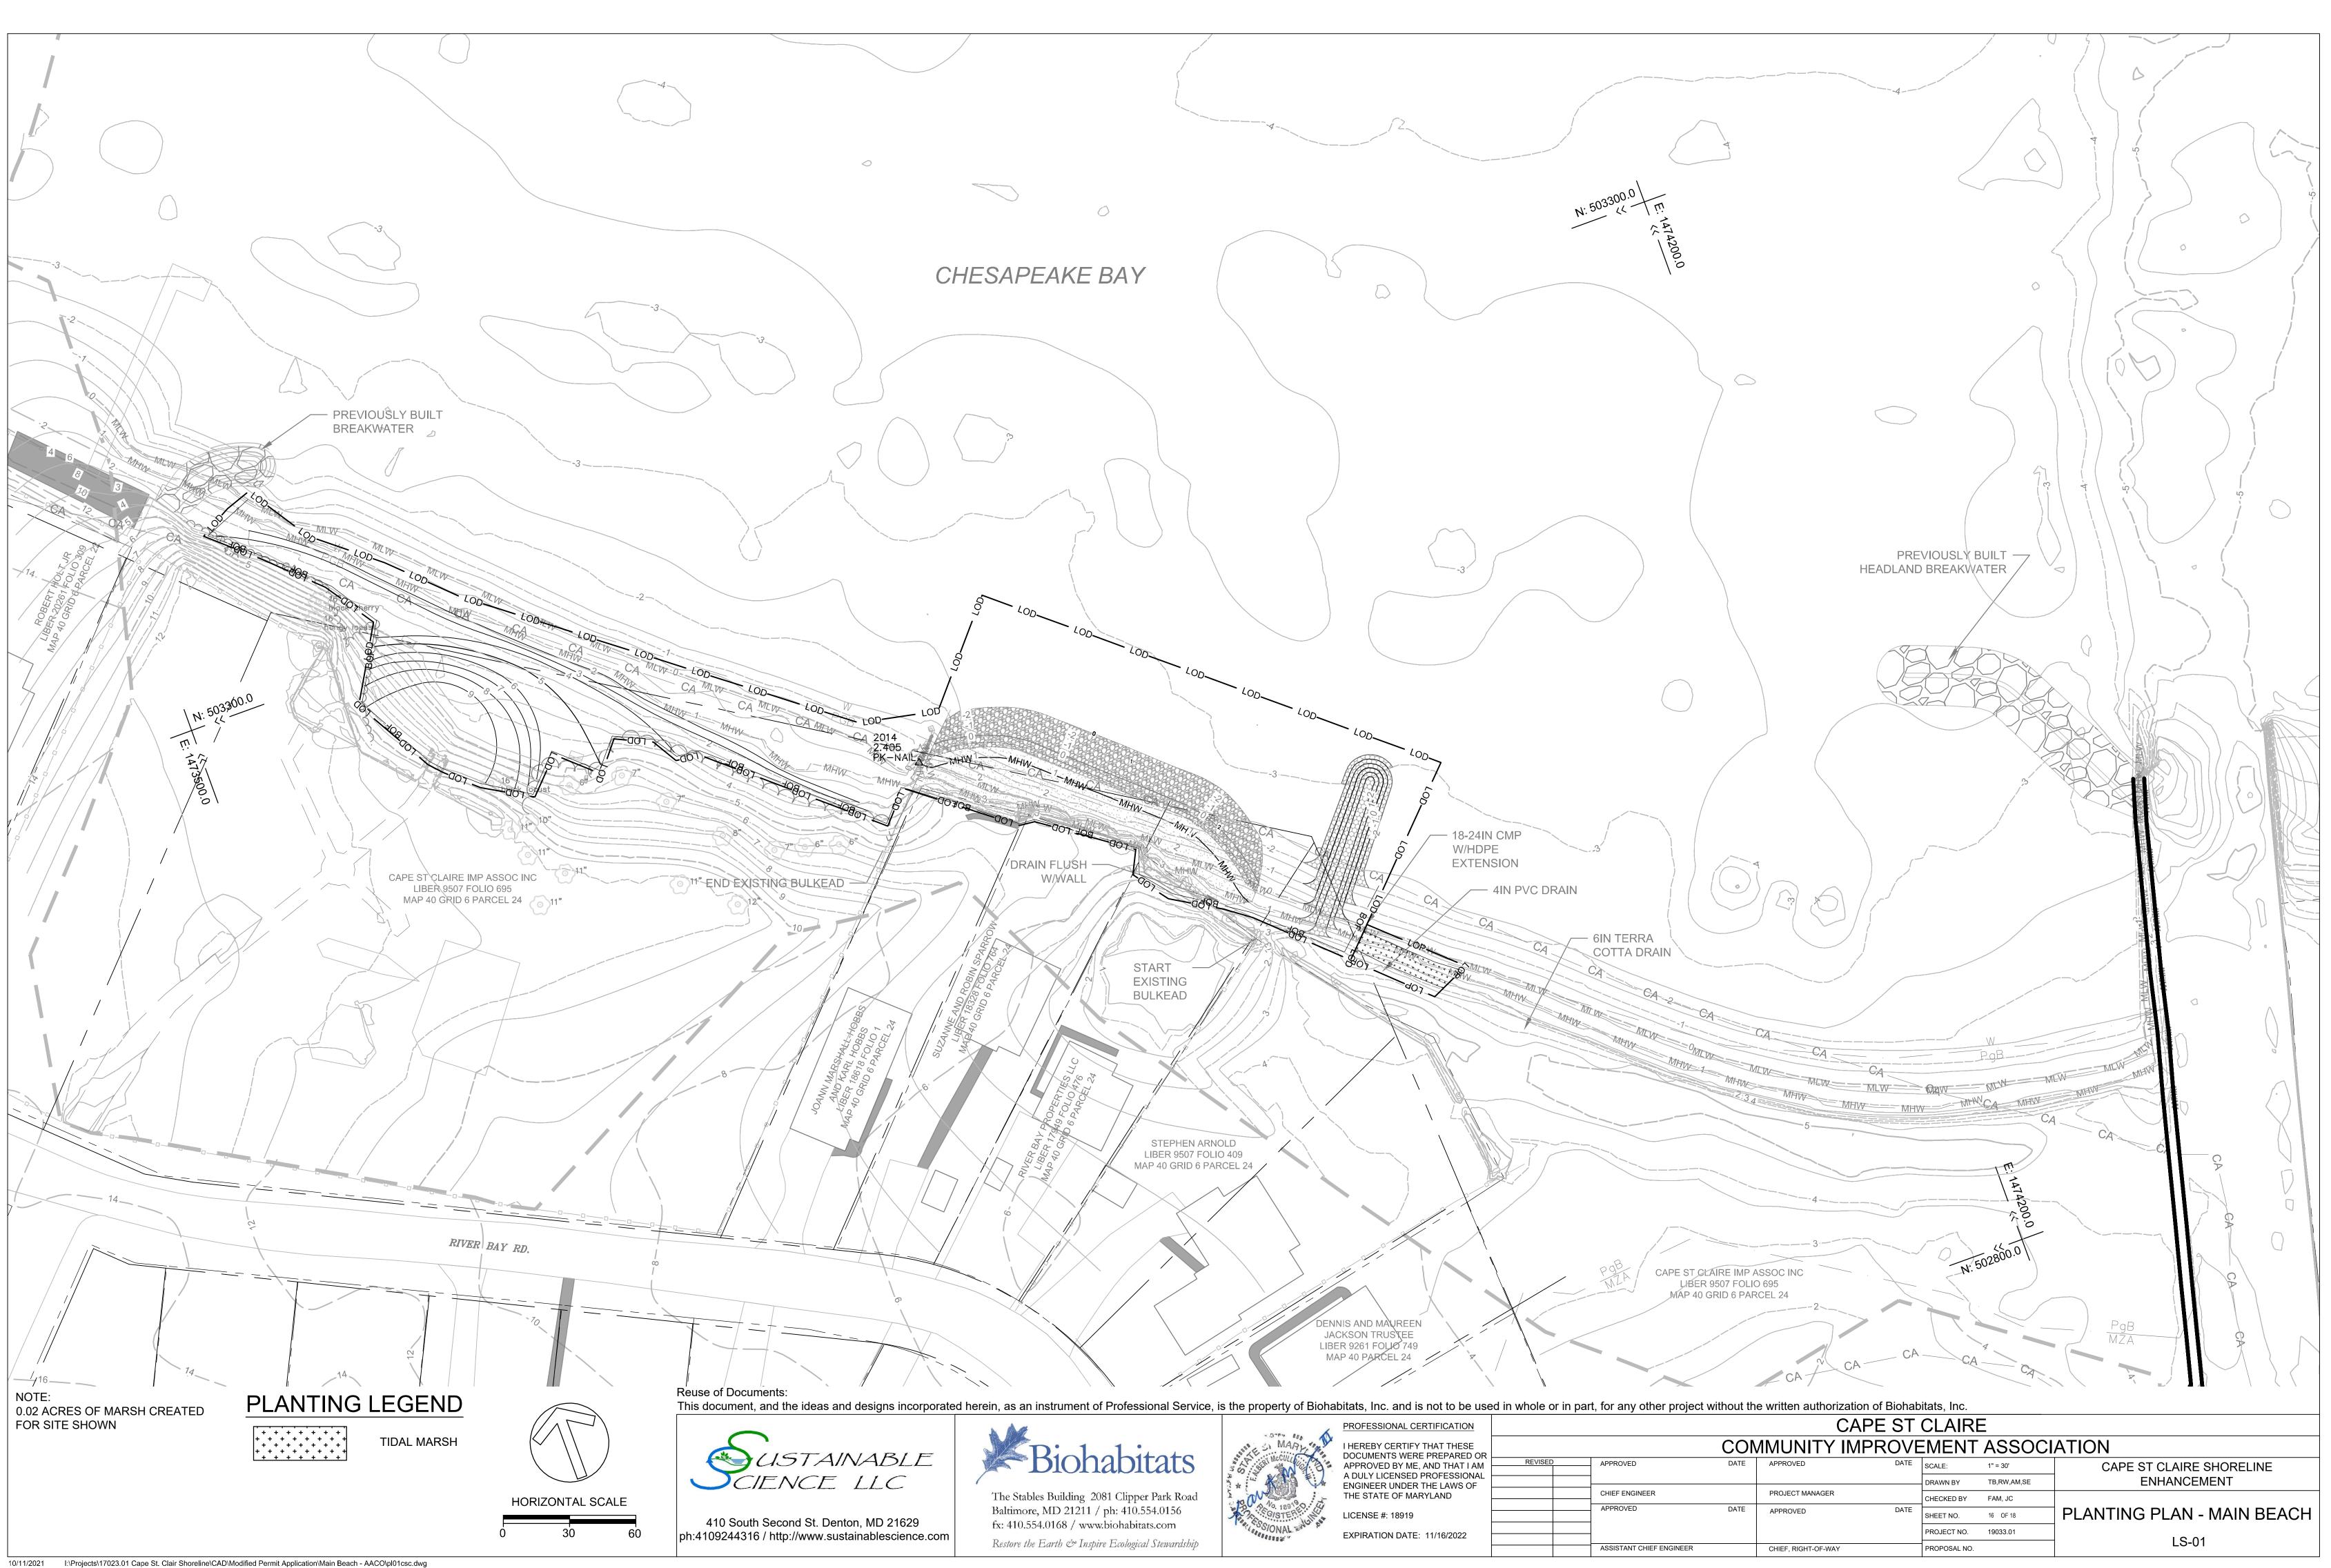
I HEREBY CERTIFY THAT THESE


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		STANDARD SYMBOL
MARINE QUALITY CLOSED CELL PLASTIC FOAM CONTINUOUS FLOA	Г	— TC — TC —
POLYESTER REINFORCED FABRIC FENCE	<u>SPE</u> 1.	ECIFICATIONS FLOATING TURBIDITY CURTAIN SHALL BE TOUGH GUY TYPE 1 OR MDDEP APPROVED EQUAL. THE CURTAIN SHALL BE MADE OF 18 OZ./SQ.YD. POLYESTER REINFORCED FABRIC (320 LB. PSI TEST) AND ALL
BALLAST (GALVANIZED CHAIN OR APPROVED EQUAL) 1/2" MIN. DIA ROPE		SEAMS SHALL BE HEAT-WELDED. THE CURTAIN SHALL HAVE A CLOSED CELL PLASTIC FOAM FLOATATION DEVICE, PROVIDING 16 LBS./FT. BUOYANCY AND SHALL BE WEIGHTED WITH A 1/4" GALVANIZED CHAIN. HEAT-WELDED INTO THE CELL AND SECURED AT BOTH ENDS TO ENABLE THE CURTAIN TO LAY FLAT. EACH CURTAIN SHALL
ANCHOR (@50' CC MAX.) SHALL BE OF ADEQUATE WEIGHT TO PREVENT DRAGGING	2. 3.	MEASURE 3' (MIN.) DEEP AND 50" IN LENGTH. THE ENDS OF EACH CURTAIN SHALL HAVE A MINIMUM OF FIVE (5) BRASS SPUR-LOCKING GROMMETS PER SIDE. A 3/16" POLY CHORD SHALL BE USED FOR TYING GROMMETS BETWEEN SECTIONS OF THE CURTAIN. CONCRETE CINDER BLOCKS SHALL BE USED AS ANCHORING.

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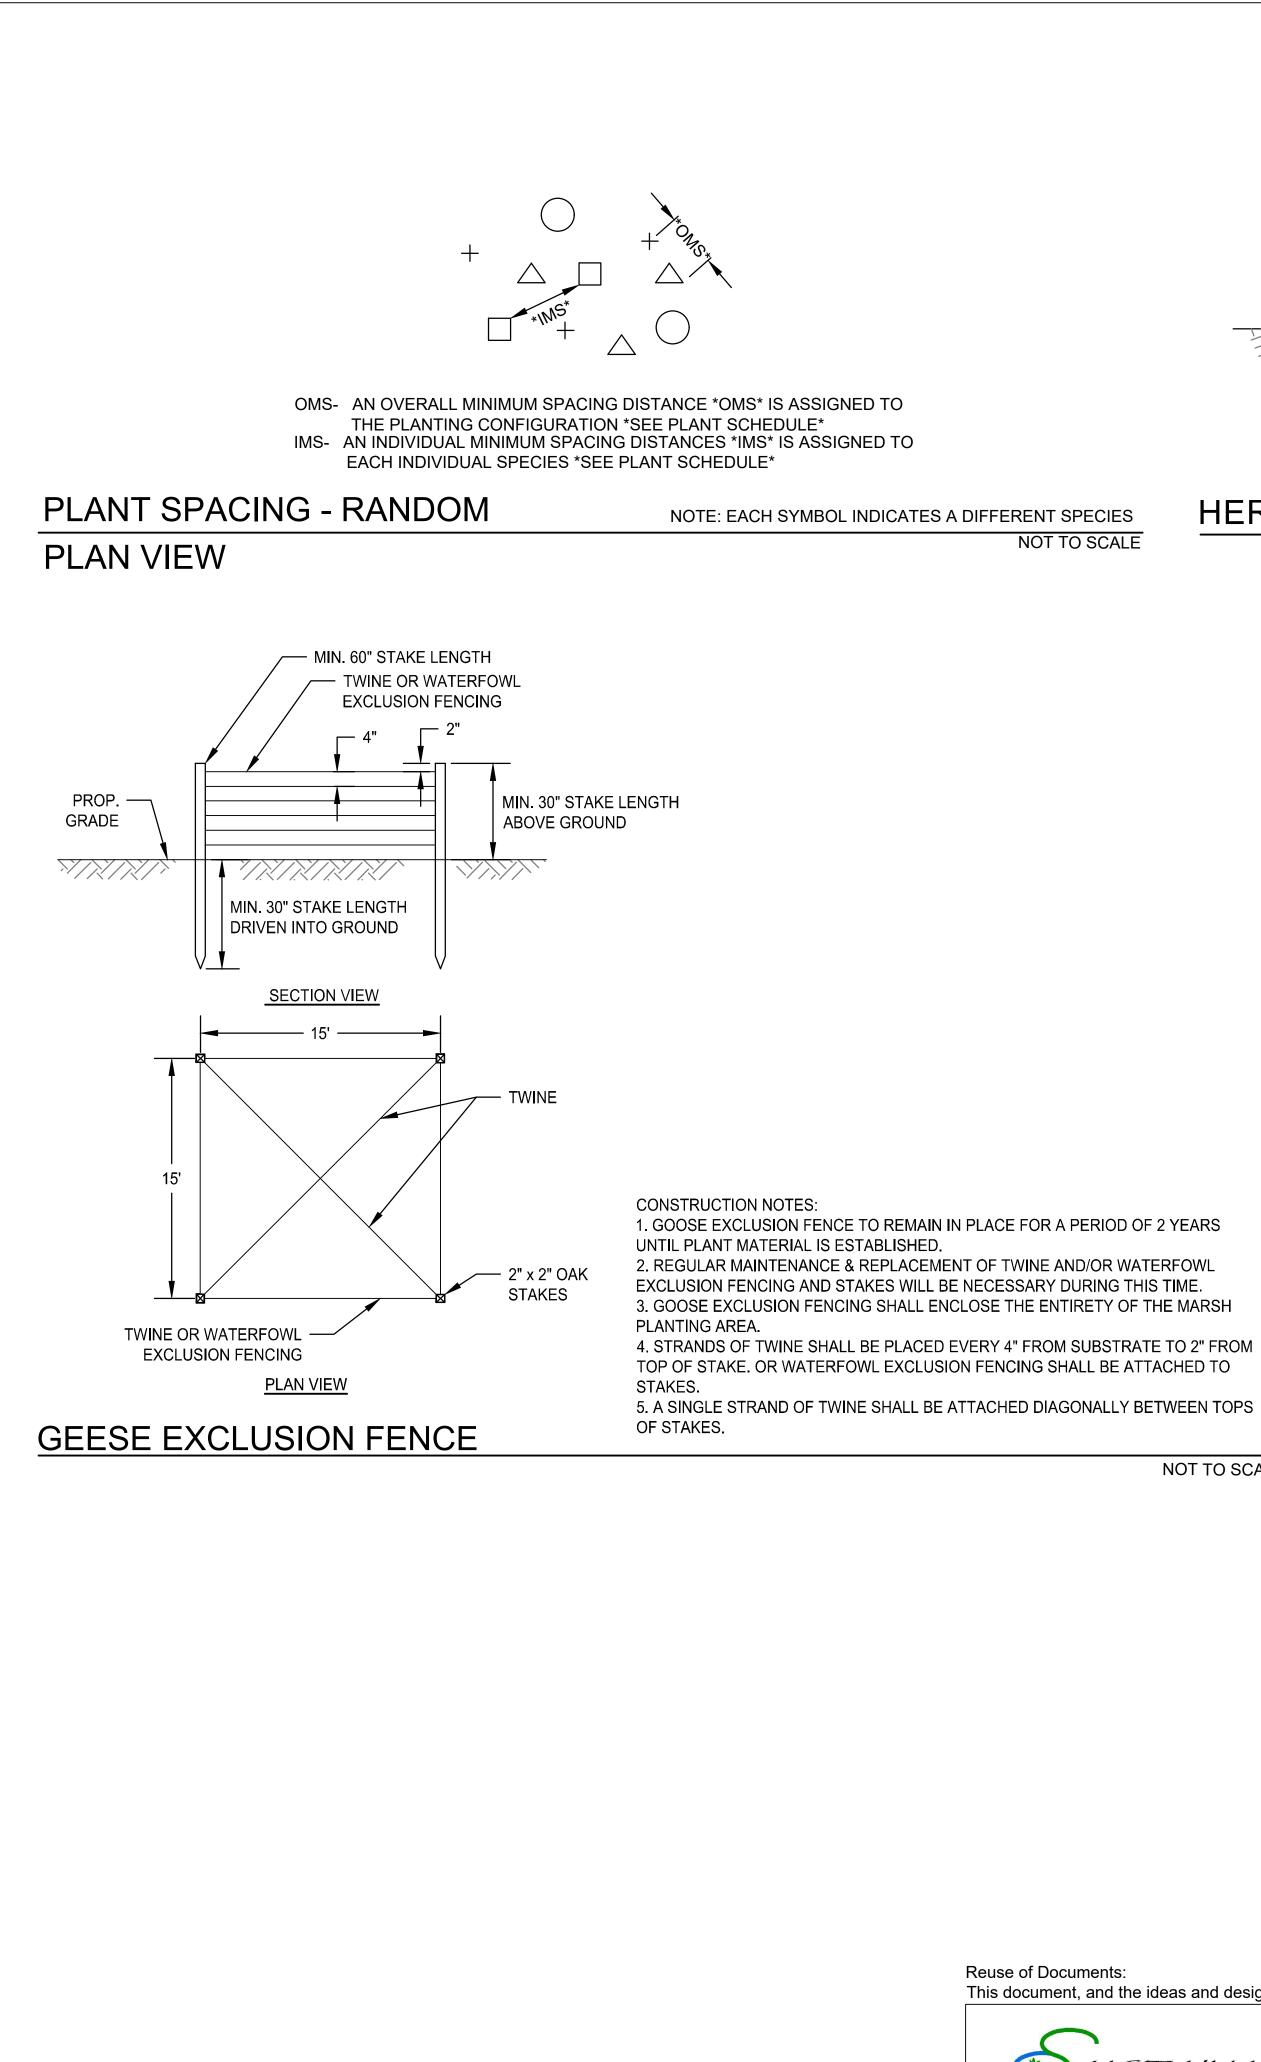
CAPE ST CLAIRE								
COMMUNITY IMPROVEMENT ASSOCIATION								
PROVED	DATE	APPROVED	DATE	SCALE:	N/A	CAPE ST CLAIRE SHORELINE		
		PROJECT MANAGER		DRAWN BY	TB,RW,AM,SE	ENHANCEMENT		
EF ENGINEER				CHECKED BY	FAM, JC	EROSION AND SEDIMENT		
PROVED	DATE	APPROVED	DATE	SHEET NO.	15 OF 18	CONTROL DETAILS		
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SISTANT CHIEF ENGINEER CHIEF, RIGHT-OF-WAY				PROPOSAL NO.		ES-05		






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— PLUG, PEAT POT, TUBER

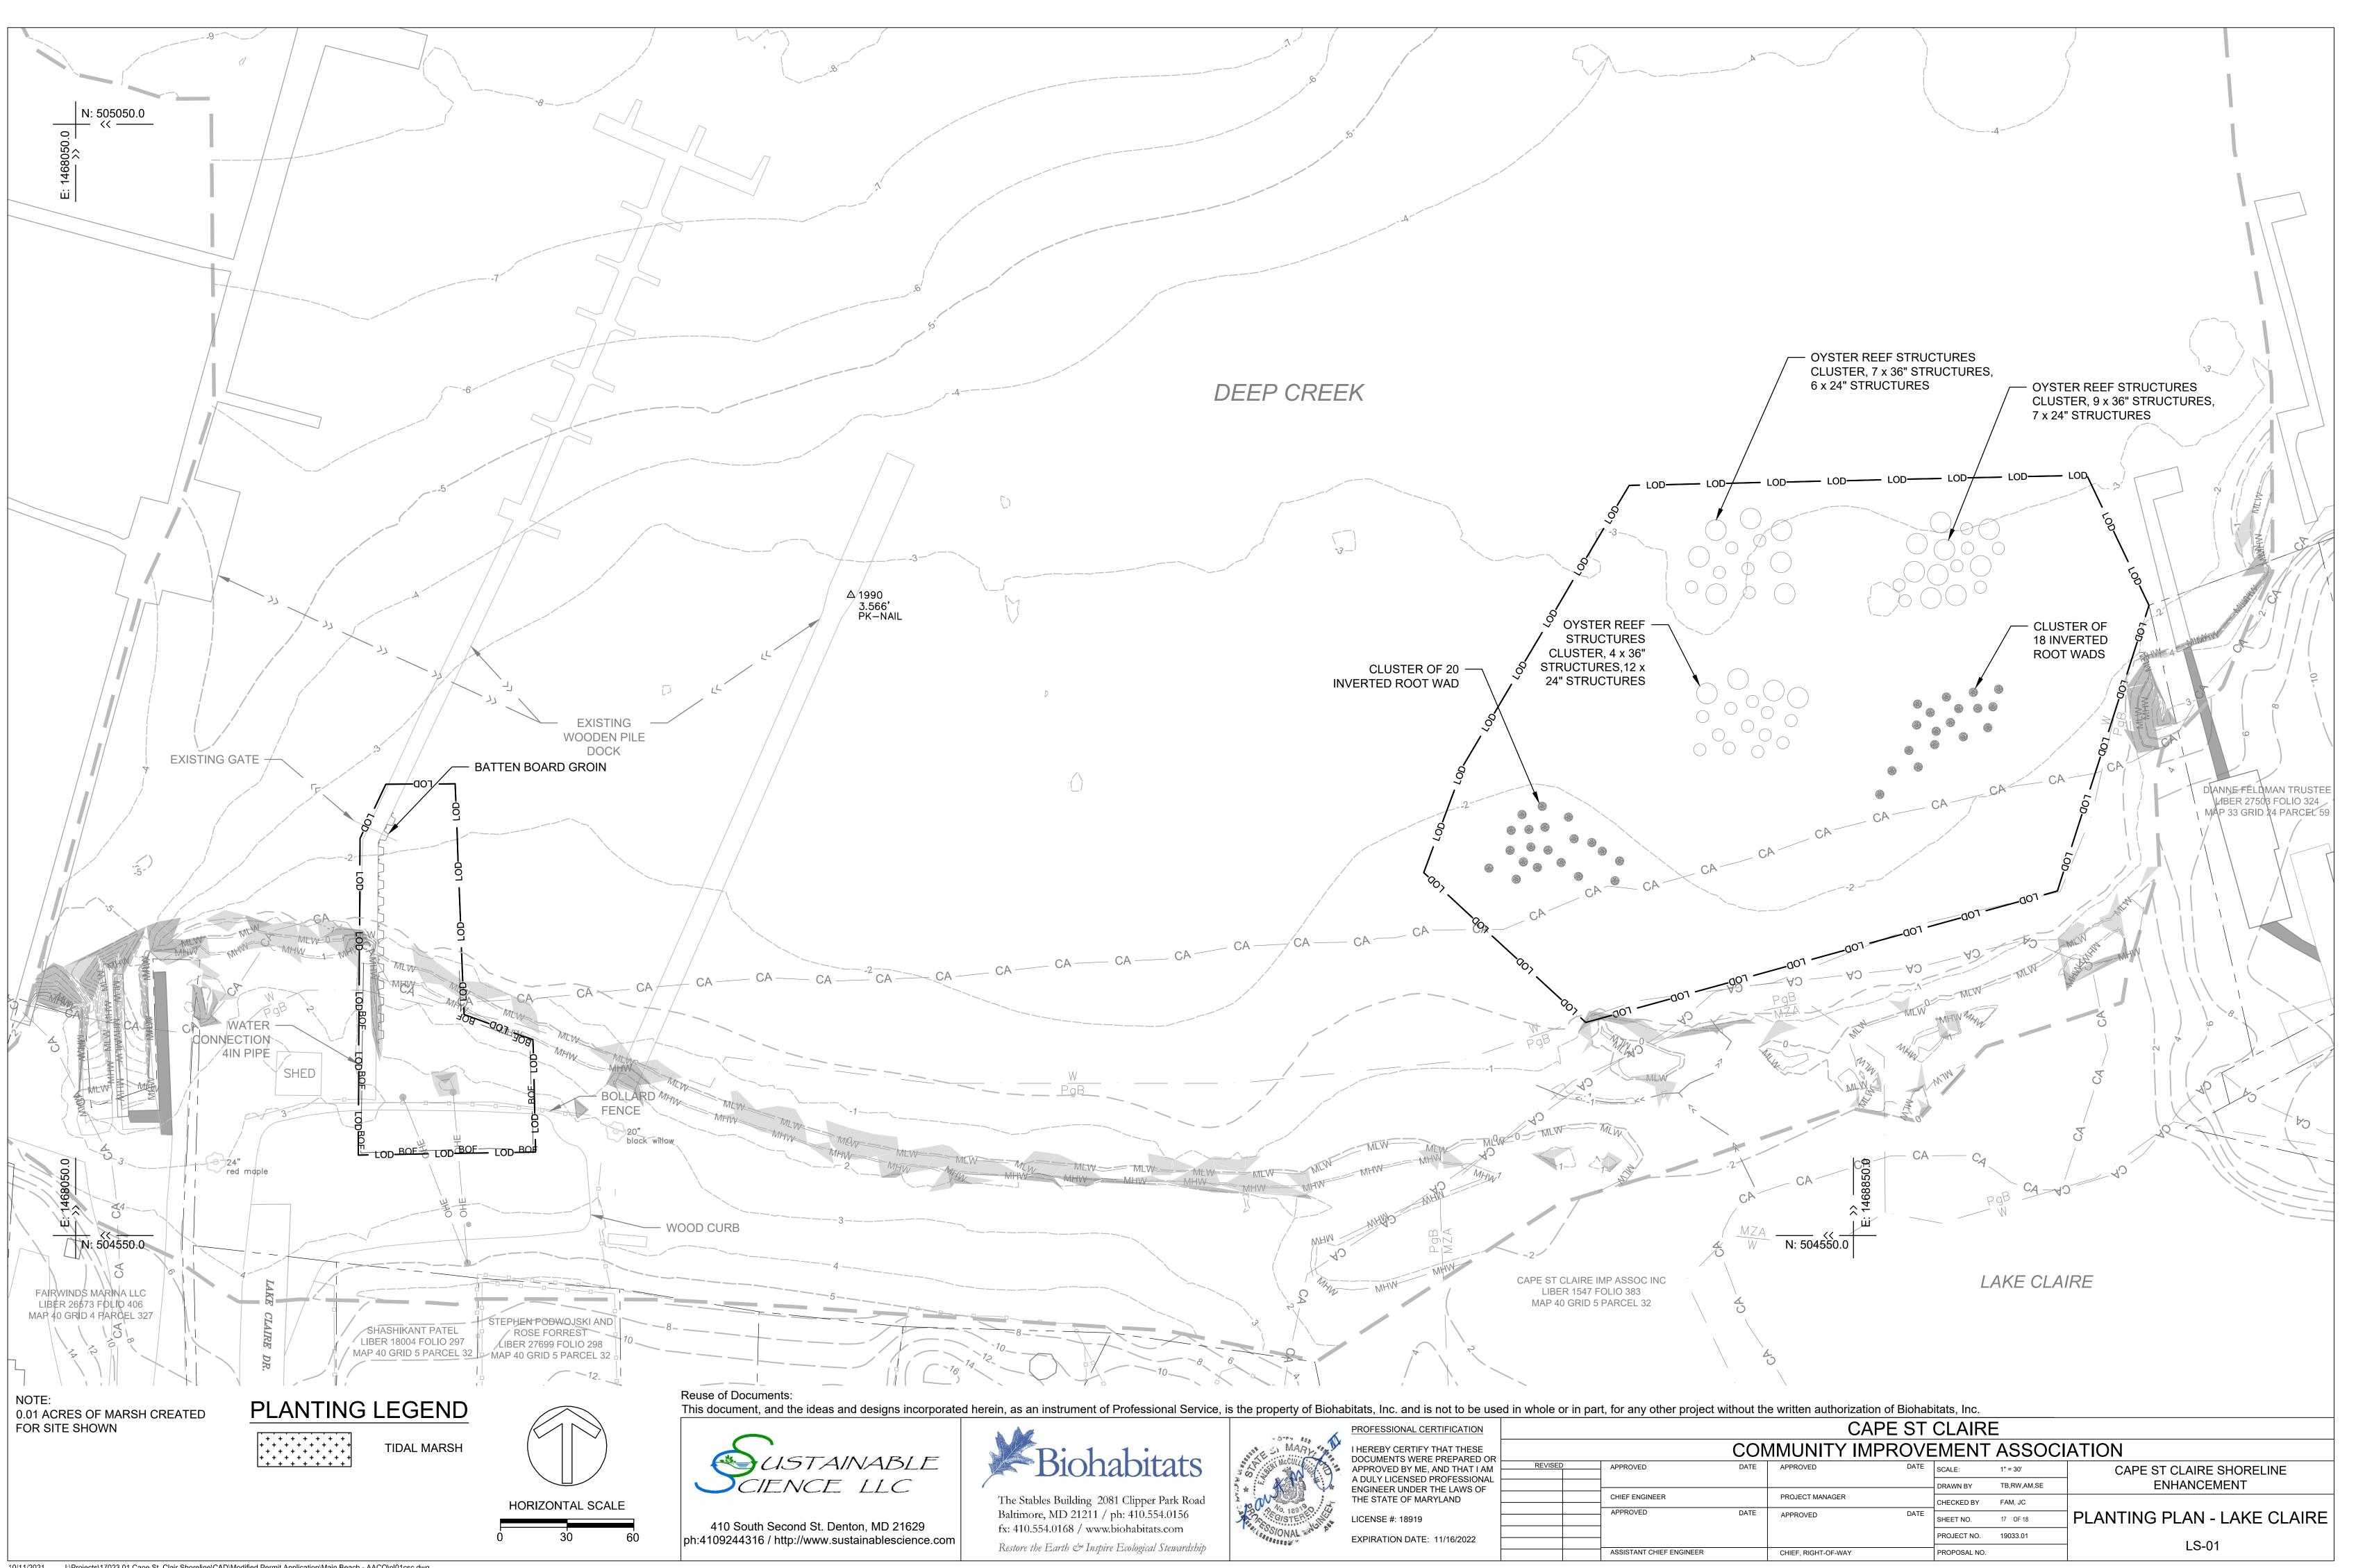- GROUND LINE TO BE THE SAME AS NURSERY

- BACKFILL WITH SOIL OR PLANTING MIX AS SPECIFIED. TAMP TO FILL ALL VOIDS AND AIR POCKETS
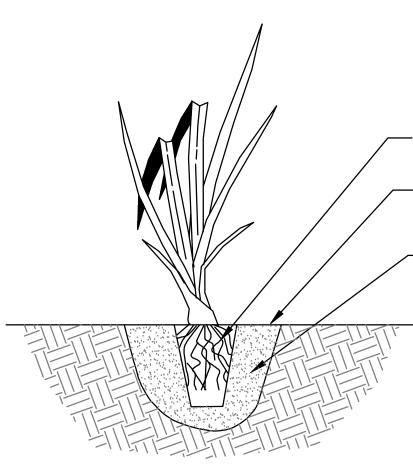
# PLANTING SCHEDULE

		_ MARSH					Size (a Size (square		
Overall Minimum Spacing (ft.)	Quantity per acre	Frequency (%)	Species Quantity	Vegetation Strata/ Species Name	Common Name	Unit	Spacing Type	Size	Individual Minimum Spacing (ft.)
1	43560			NATIVE PLUG					
		20	89	Spartina patens	saltmarsh hay	PLUG*	Clump	2"	N/A
		10	45	Distichlis spicata	saltgrass	PLUG*	Clump	2"	N/A
		15	67	Panicum virgatum	switchgrass	PLUG*	Clump	2"	N/A
		5	22	Solidago sempervirens	seaside goldenrod	PLUG*	Clump	2"	N/A
		40	178	Spartina alterniflora	smooth cordgrass	PLUG*	Clump	2"	N/A
		10	45	Scirpus robustus	saltmarsh bulrush	PLUG*	Clump	2"	N/A
		100	446	= total		•	•	•	

# HERBACEOUS PLANTING - PLUGS

NOT TO SCALE

NOT TO SCALE

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PROFESSIONAL CERTIFICATION I HEREBY CERTIFY THAT THESE DOCUMENTS WERE PREPARED OR APPROVED BY ME, AND THAT I AM A DULY LICENSED PROFESSIONAL ENGINEER UNDER THE LAWS OF THE STATE OF MARYLAND LICENSE #: 18919 EXPIRATION DATE: 11/16/2022

REVISED	APPRO
	CHIEF E
	APPRO
	ASSIST

CAPE ST CLAIRE									
COMMUNITY IMPROVEMENT ASSOCIATION									
ROVED	DATE	APPROVED	DATE	SCALE:	NTS	CAPE ST CLAIRE SHORELINE			
				DRAWN BY	TB,RW,AM,SE	ENHANCEMENT			
EF ENGINEER		PROJECT MANAGER		CHECKED BY	FAM, JC				
ROVED	DATE	APPROVED	DATE	SHEET NO.	18 OF 18	PLANTING DETAILS			
				PROJECT NO.	19033.01				
ISTANT CHIEF ENGINEER		CHIEF, RIGHT-OF-WAY		PROPOSAL NO.		LS-03			